

KOSSUTH WATER ASSOCIATION WATER SYSTEM IMPROVEMENTS WENASOGA AREA CDBG PROJECT # 1136-19-225-PF-01

SCALE:
1"=1,500'

ISSUE DATE:
APRIL 22, 2020

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1713A City Ave. N
Ripley, MS 38663
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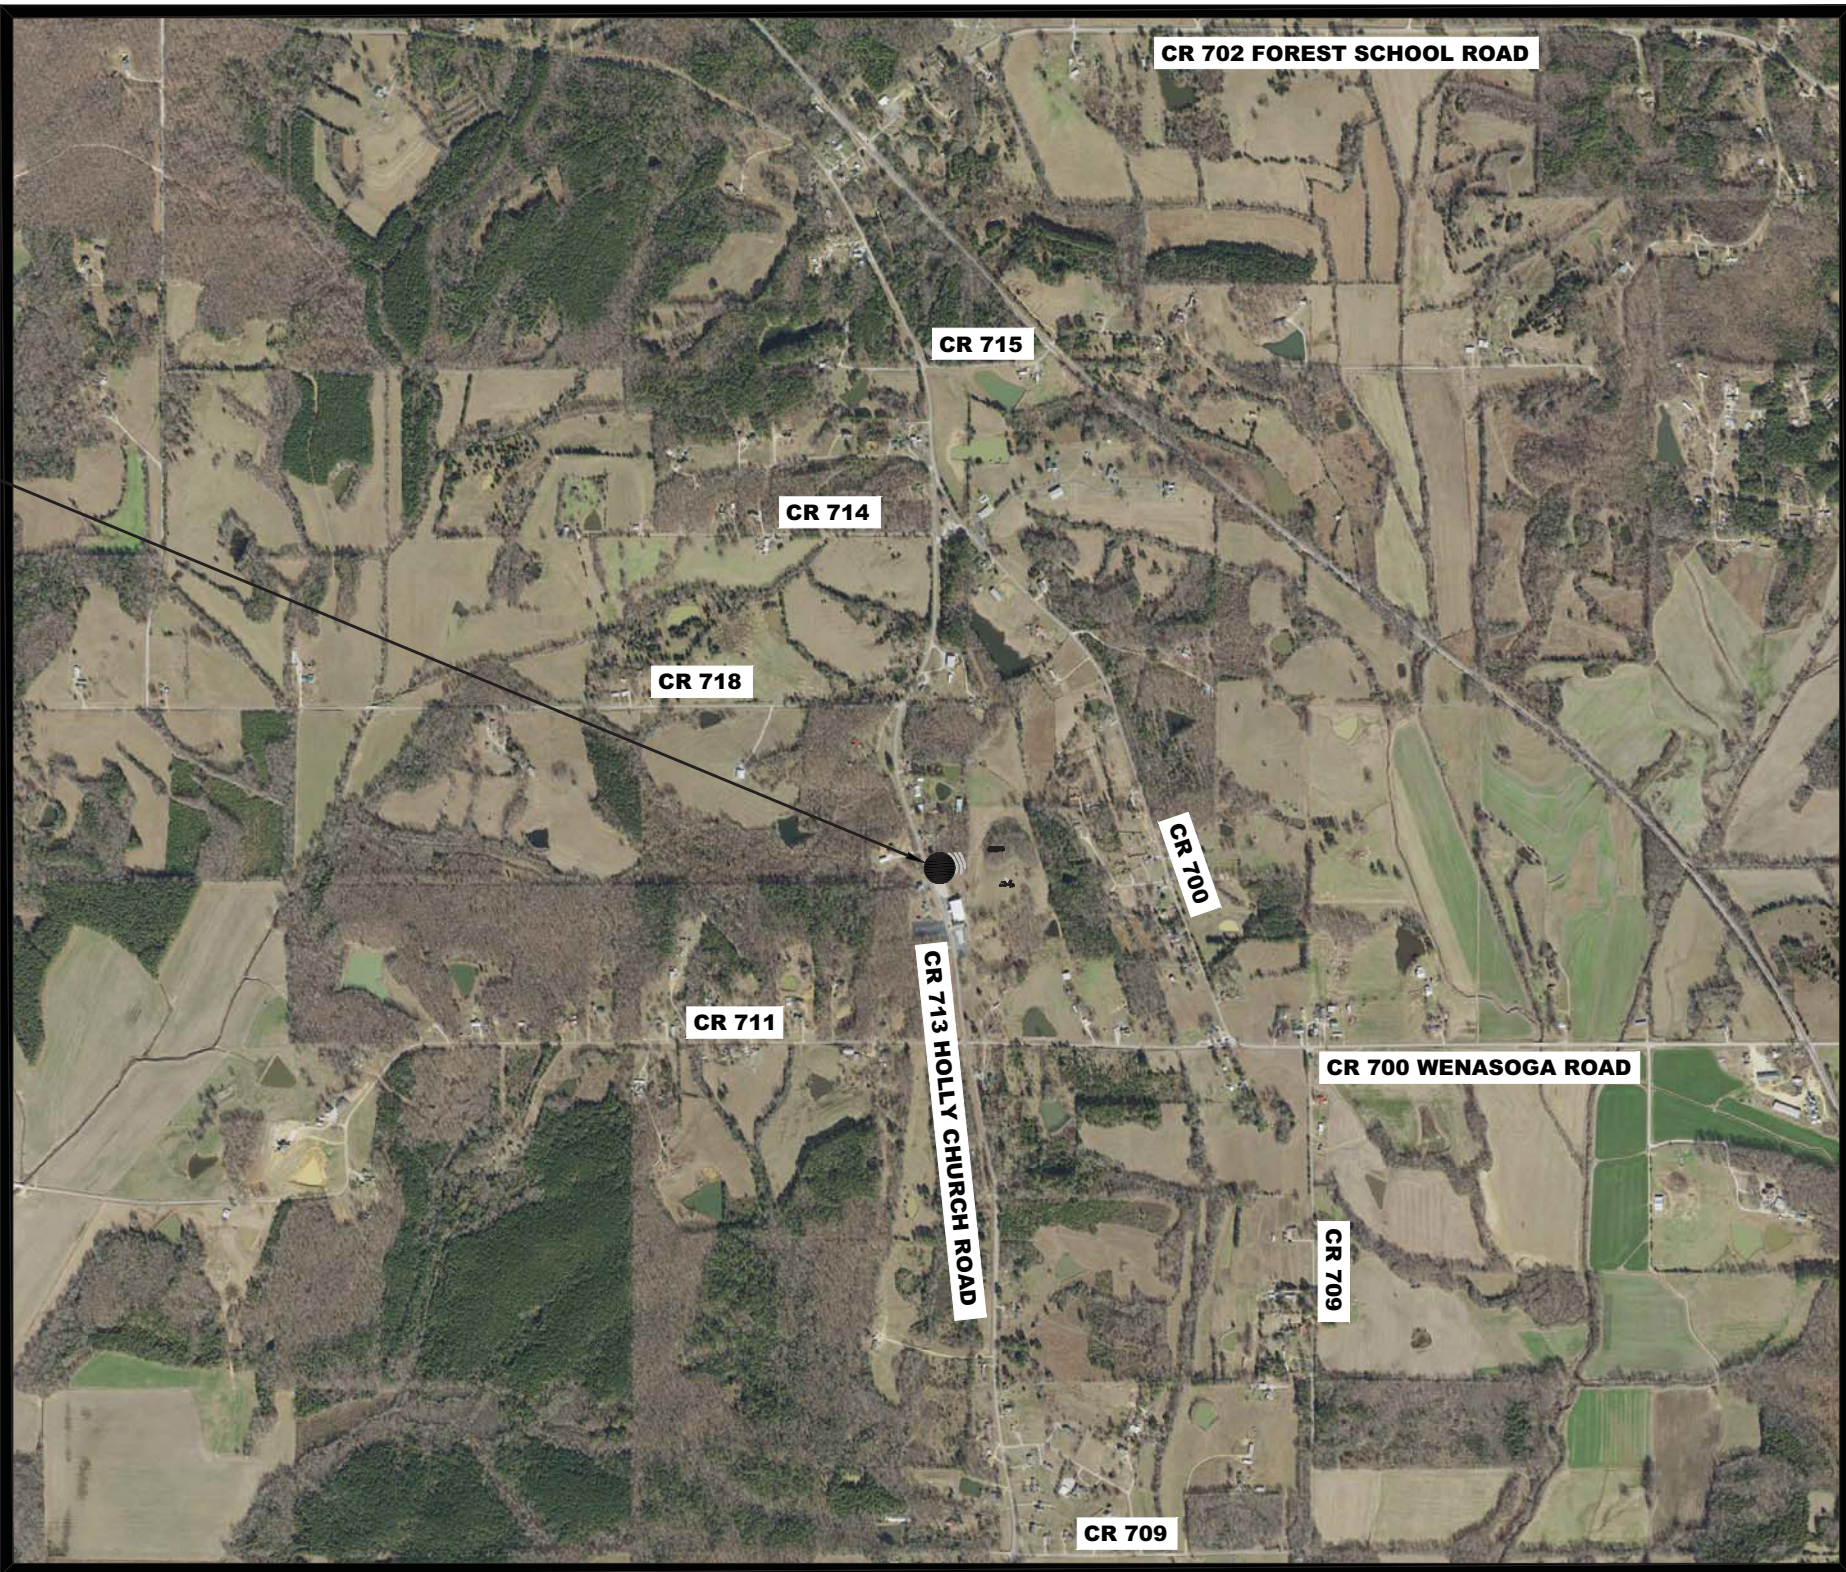
REVISIONS
IFB: APRIL 22, 2019

PROJECT TITLE:	KOSSUTH WATER ASSOCIATION WATER SYSTEM IMPROVEMENTS – WENASOGA AREA CDBG PROJECT NO. 1136-19-225-PF-01
SHEET TITLE:	COVER SHEET


PROJECT NO.	KWA-19003
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SHEET NO.	C-0.0
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PROPOSED WELL SITE



VICINITY MAP



OWNER:

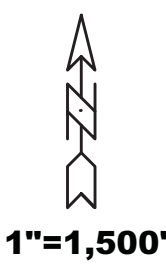KOSSUTH WATER ASSOCIATION
10 COUNTY ROAD 613
CORINTH, MS 38634



SHEET INDEX	
C-0.0	COVER SHEET
C-1.0	WELL SITE PLAN
C-2.0	WELL GRADING PLAN
D-1.0	CHEMICAL BUILDING DETAILS
D-2.0	WELL DETAILS
D-3.0	MISCELLANEOUS DETAILS
D-4.0	MISCELLANEOUS DETAILS

LEGEND	
— W — W — W — W —	EXISTING WATER LINE
— S — S — S — S —	EXISTING SEWER LINE
— FM — FM — FM — FM —	EXISTING FORCE MAIN
— G — G — G — G —	EXISTING GAS LINE
— FD — FD — FD — FD —	EXISTING FIBER OPTIC LINE
— OHE — OHE — OHE — OHE —	EXISTING OVERHEAD ELECTRIC LINE
— UGE — UGE — UGE — UGE —	EXISTING UNDERGROUND ELECTRIC LINE
— — — — —	EXISTING PROPERTY LINE
— — — — —	EXISTING EASEMENT
— — — — —	PROPOSED VALVE
— — — — —	PROPOSED FIRE HYDRANT ASSEMBLY
— W — W — W — W —	PROPOSED WATER LINE
— — — — —	PROPOSED EASEMENT

MUNICIPAL OFFICIALS

MAYOR
DONALD PACE

ALDERMAN
JAMES ALLEN
DUSTY ESSARY
STEVE JONES
PAUL ROLISON
BILLY WHITE


TOWN CLERK
RANDY HOLT

TOWN ATTORNEY
NICK BAIN



S. MARK WARD
MS PE - 14249, MS PLS - 02850

REVIEW OF THESE PLANS IS LIMITED TO GENERAL COMPLIANCE WITH LOCAL CODES AND REGULATIONS AND DOES NOT WARRANT THE ENGINEER'S DESIGN OR RELIEVE THE CONTRACTOR OF ANY REQUIREMENTS, EVEN IF ERRORS, OMISSIONS, OR ANY INADEQUACIES ARE DISCOVERED AFTER PLAN APPROVAL. THE LOCAL CODES SHALL GOVERN, IF ANY CONFLICTS OCCUR WITH THE PLANS OR SPECIFICATIONS.

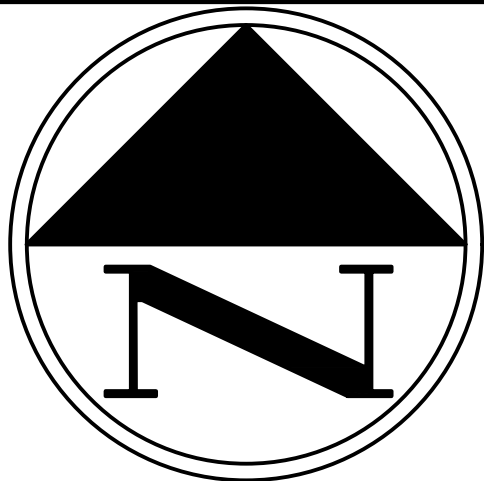

GRID BEARINGS
OPUS SOLUTION
COORDINATES SHOWN ARE
SPC 2301 MS E NAD83(2011)
COMBINED SCALE FACTOR: 0.99993522
CONVERGENCE: 00°08'51.68"

0 10 20 Feet

SCALE:
1"=10'

ISSUE DATE:
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REVISIONS

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PROJECT TITLE:

KOSSUTH WATER ASSOCIATION
WATER SYSTEM IMPROVEMENTS – WENASOGA AREA
CDBG PROJECT NO. 1136-19-225-PF-01

SHEET TITLE:

WELL SITE PLAN

PROJECT NO.

KWA-19003

SHEET NO.

C-1.0

N 89°45'50" E
304.34'

SITE SPECIFIC NOTES:

ANY CLEARING, GRUBBING, AND/OR GRADING WORK NEEDED FOR WELL DEVELOPMENT IS INCLUDED UNDER CONTRACT.

CONTRACTOR SHALL BE RESPONSIBLE FOR ACQUIRING ANY PERMITS OR FEES REQUIRED FOR THE DEMOLITION AND APPROPRIATE DISPOSAL OF ALL CONSTRUCTION DEBRIS AND RUBBISH GENERATED FROM PROJECT CONSTRUCTION.

ALL DEBRIS, TRASH, RUBBISH AND OTHER DEMOLISHED MATERIAL SHALL BE PROPERLY DISPOSED OF OFF SITE. NO ON-SITE BURNING OR BURYING SHALL BE ALLOWED.

CONTRACTOR SHALL COORDINATE WATER TIE-INS WITH THE TOWN OF KOSSUTH UTILITY DEPARTMENT. NO WATER SERVICE DISRUPTION SHALL BE ALLOWED WITHOUT PRIOR APPROVAL FROM THE TOWN OF KOSSUTH UTILITY DEPARTMENT.

"REVIEW OF THESE PLANS IS LIMITED TO GENERAL COMPLIANCE WITH LOCAL CODES AND REGULATIONS AND DOES NOT WARRANT THE ENGINEER'S DESIGN OR RELIEVE THE DEVELOPER OF ANY REQUIREMENTS, EVEN IF ERRORS, OMISSIONS, OR ANY INADEQUACIES ARE DISCOVERED AFTER PLAN APPROVAL. THE LOCAL CODES SHALL GOVERN IF ANY CONFLICTS OCCUR WITH THE PLANS OR SPECIFICATIONS. ANY CONDITIONS DETERMINED IN THE FIELD WHICH REQUIRE CHANGES SHALL BE SUBJECT TO FURTHER REVIEW AND CORRECTIVE ACTION."

GENERAL NOTES

1. THE LOCATION OF THE EXISTING UTILITIES ARE BASED ON RECORDS FROM SAID UTILITY COMPANIES AND ARE HORIZONTALLY FIELD LOCATED ONLY. THE CONTRACTORS SHALL BE RESPONSIBLE FOR CONTACTING MISSISSIPPI ONE CALL(811 OR 1-800-227-6477) AND DETERMINING THE EXACT LOCATION OF ALL UTILITIES(PUBLIC & PRIVATE) PRIOR TO THE START OF CONSTRUCTION.
2. PRIOR TO THE INSTALLATION OF ANY DRAINAGE OR UTILITY LINE, THE CONTRACTOR SHALL EXCAVATE, VERIFY, AND CALCULATE ALL CROSSINGS AND INFORM THE ENGINEER OF ANY CONFLICTS PRIOR TO PROCEEDING WITH CONSTRUCTION. THE ENGINEER WILL BE HELD HARMLESS IN THE EVENT THE ENGINEER IS NOT NOTIFIED OF ANY CONFLICTS THAT MIGHT ARISE.
3. CONTRACTOR SHALL BEAR ALL RESPONSIBILITY AND COST OF REPAIR OR REPLACEMENT OF EXISTING UTILITIES DAMAGED OR INTERRUPTED AS A RESULT OF THIS CONSTRUCTION PROJECT.
4. CONTRACTOR SHALL NOTIFY THE PROJECT ENGINEER AND THE OWNER OF ANY DAMAGED OR INTERRUPTED UTILITIES IMMEDIATELY.
5. ALL WATER LINES AND APPURTENANCES SHALL BE INSTALLED IN ACCORDANCE WITH THE CURRENT CODES.
6. CONTRACTOR SHALL NOTIFY PROJECT ENGINEER IN WRITING 48 HOURS PRIOR TO BEGINNING WORK.
7. ANY AREAS TO BE PAVED ARE TO RECEIVE A GRAVEL BASE TO PROVIDE EROSION CONTROL IF WORK IS NOT PROGRESSING IN AN ORDERLY MANNER. A RATE OF 135 TONS/ACRE IS TO BE APPLIED WITHIN TWO WEEKS OF FINAL GRADING.
8. ALL AREAS NOT TO BE PAVED ARE TO RECEIVE LOOSE STRAW TO PROVIDE EROSION CONTROL IF WORK IS NOT PROGRESSING IN AN ORDERLY MANNER. A RATE OF 1.5 TONS/ACRE IS TO BE APPLIED WITHIN TWO WEEKS OF FINAL GRADING.
9. CONTRACTOR WILL CONTROL AND PREVENT OFF-SITE TRACKING OF CONSTRUCTION RUNOFF AND SEDIMENT TO ADJACENT PROPERTY AND PUBLIC ROADS.
10. ALL SITE WORK FOR THIS PROJECT SHALL MEET OR EXCEED MDOT AND THE MANUFACTURES STANDARD DRAWINGS AND SPECIFICATIONS.
11. ALL UTILITIES, SLEEVING, AND STORM DRAIN PIPE UNDER PAVED AREAS SHALL RECEIVE SELECT BACKFILL FULL DEPTH COMPACTED TO 95% MODIFIED PROCTOR.
12. THE INTENT OF THESE PLANS IS TO DESCRIBE THE COMPONENTS OF A COMPLETE WATER PRODUCTION WELL, READY TO USE, IN ACCORDANCE WITH THE SCOPE OF WORK IN THE TECHNICAL SPECIFICATIONS.
13. ALL PITS USED FOR DRILLING SHALL BE FILLED AND COMPACTED BACK TO ORIGINAL CONDITION.
14. THE CONTRACTOR SHALL PROVIDE ELECTRICAL SERVICE POLE, METER, AND SECURITY LIGHTING PER UTILITY REQUEST AT THE LOCATION PREFERRED BY THE UTILITY. POWER FROM SERVICE POLE TO WELL HOUSE SHALL BE INSTALLED UNDERGROUND. PRICE FOR ELECTRICAL SERVICE SHALL BE ABSORBED IN THE BASE BID.
15. CONTRACTOR IS RESPONSIBLE FOR KEEPING ENTRANCE TO CONSTRUCTION SITES MAINTAINED AND SHAPED DURING AND POST CONSTRUCTION.
16. GRASSING IS REQUIRED ON ALL DISTURBED AREAS ON SITE. GRASSING METHODS SHALL BE IN ACCORDANCE WITH THE TECHNICAL SPECIFICATIONS. PERMANENT VEGETATIVE COVER MUST BE ESTABLISHED TO THE SATISFACTION OF THE ENGINEER BEFORE THE PROJECT WILL BE ACCEPTED.
17. IN THE EVENT OF A DISCREPANCY BETWEEN THE WRITTEN BOOK OF SPECIFICATIONS AND THESE NOTES, THE MORE STRINGENT CONDITION SHALL GOVERN.

0.86 Acres


S 89°45'50" W
260.53'

Holly Baptist Church Property
(D.B. 157, Pg. 366)

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N 89°45'50" E
304.34'



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REVISIONS

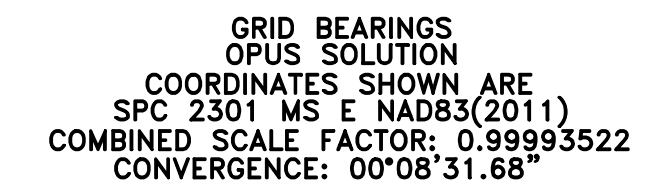WELL & TANK GRADING PLAN

SHEET NO.

C-2.0





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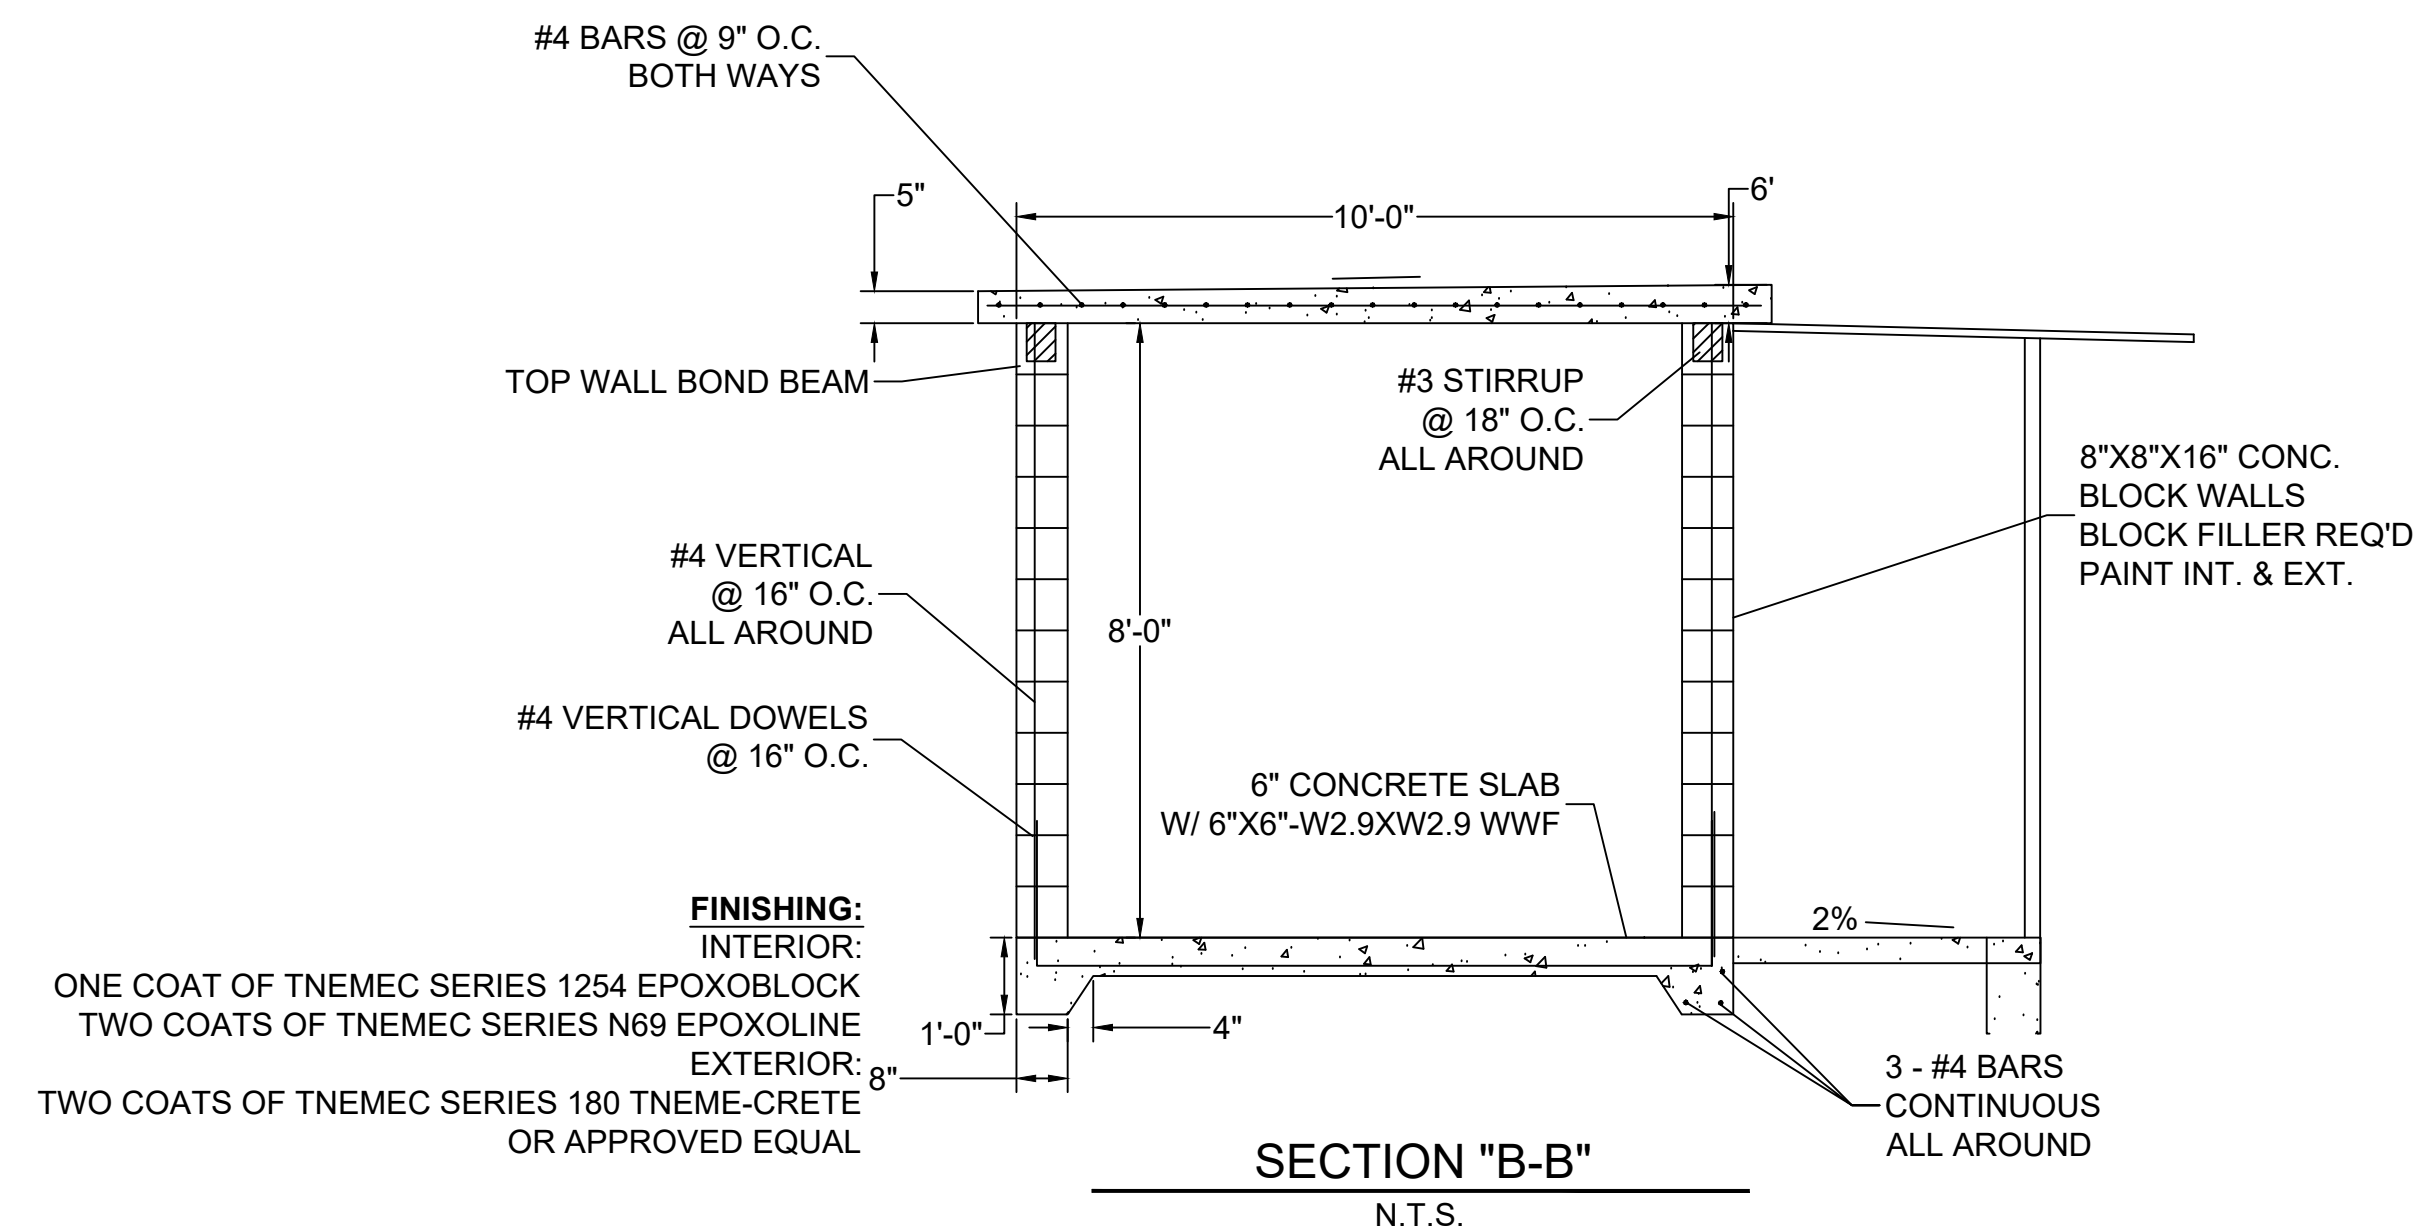
PROJECT TITLE:	KOSSUTH WATER ASSOCIATION WATER SYSTEM IMPROVEMENTS – WENASOGA AREA CDBG PROJECT NO. 1136-19-225-PF-01
SHEET TITLE:	CHEMICAL BUILDING DETAILS

PROJECT NO.	KWA-19003
SHEET NO.	D-1.0




NOTES:
PRECISE PLACEMENT OF PIPING & EQUIPMENT SHALL BE FIELD DETERMINED AND APPROVED BY OWNER/ENGINEER.

ALL CHEMICAL PUMPS TO BE CONTROLLED BY THE WELL STARTER.

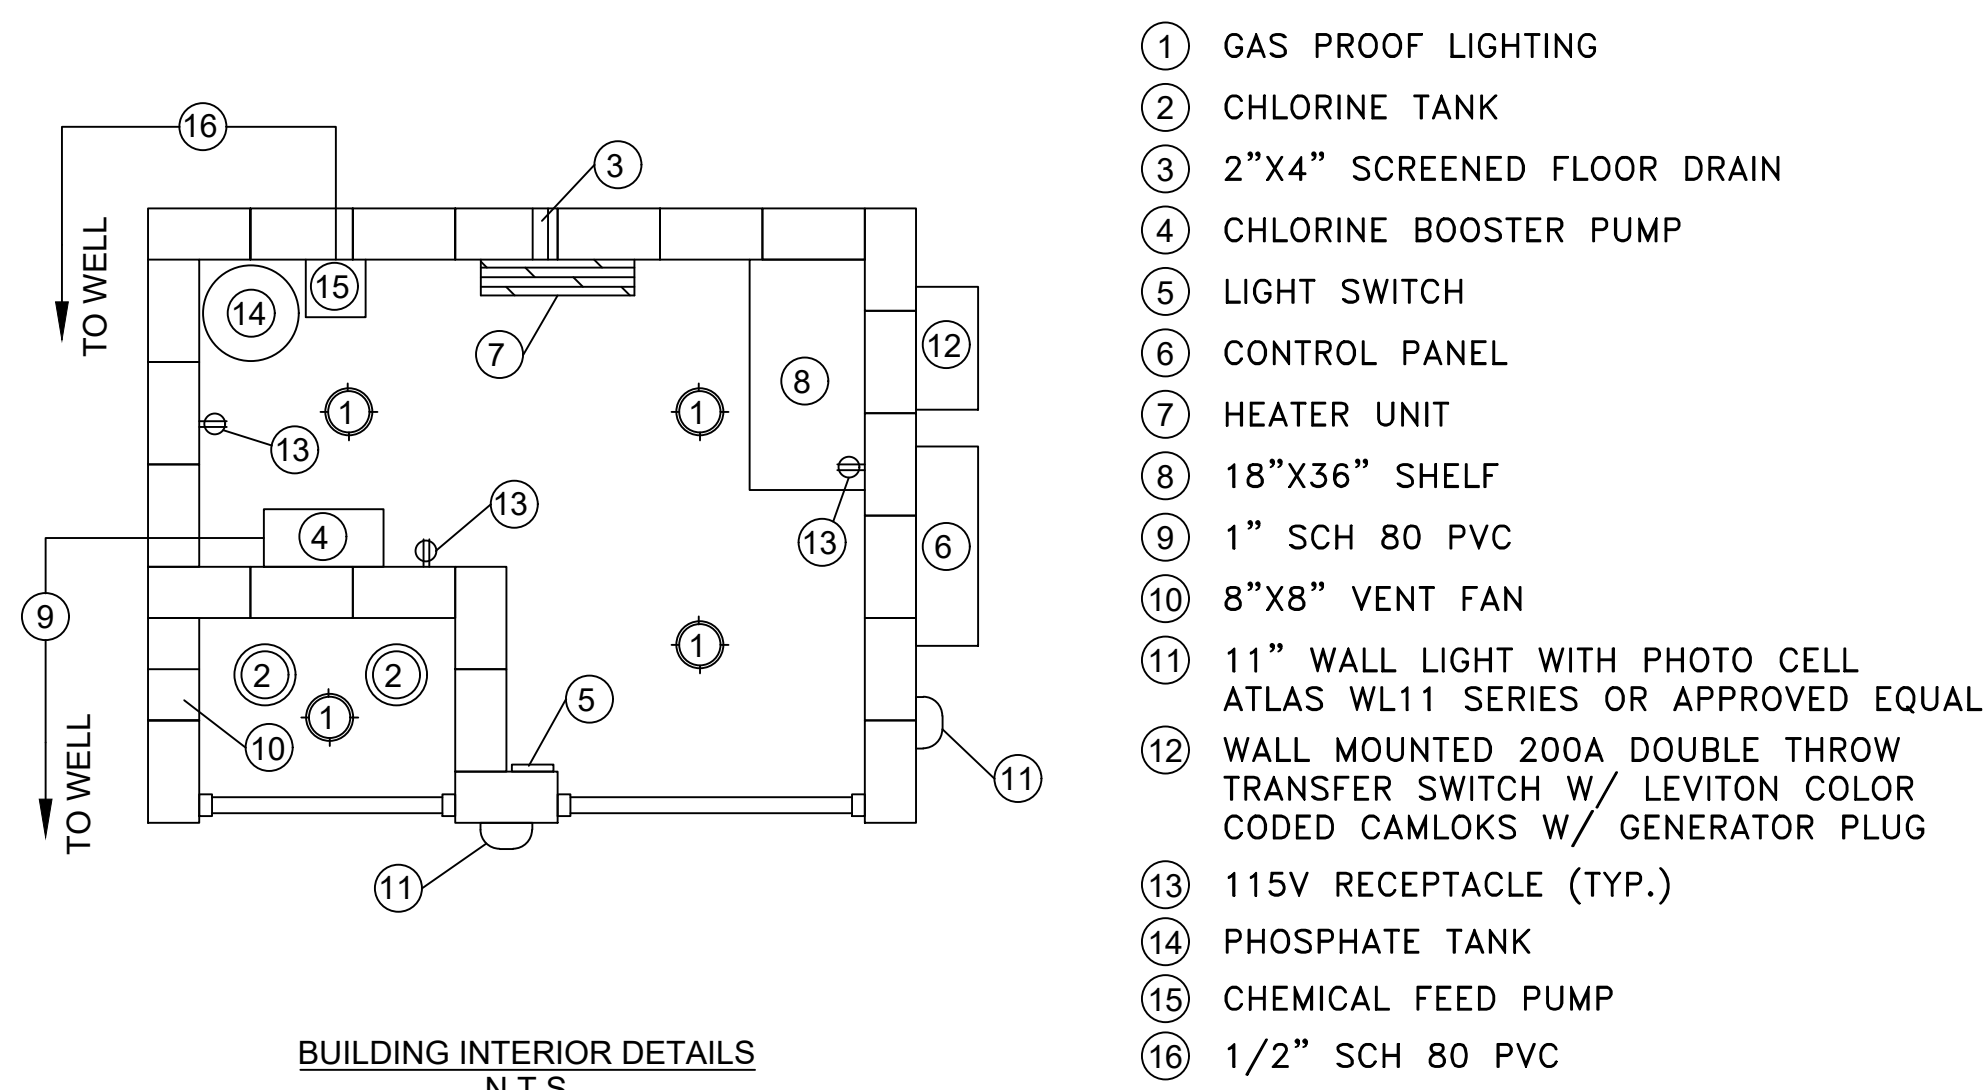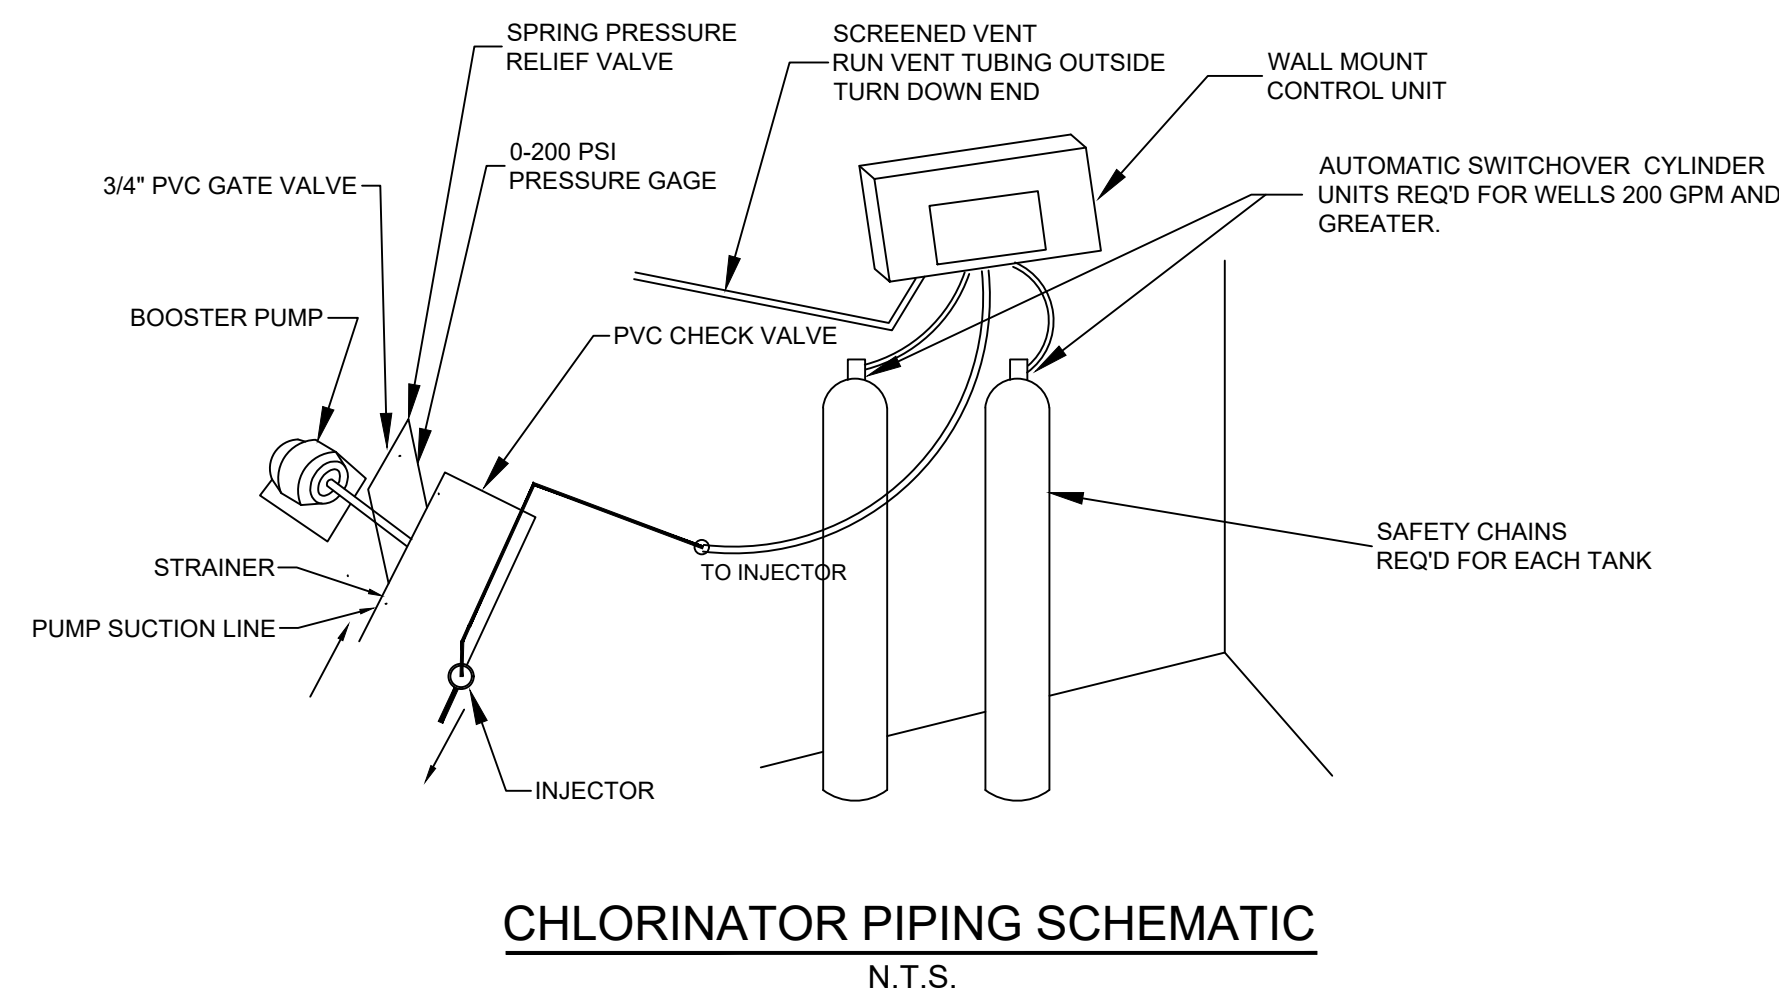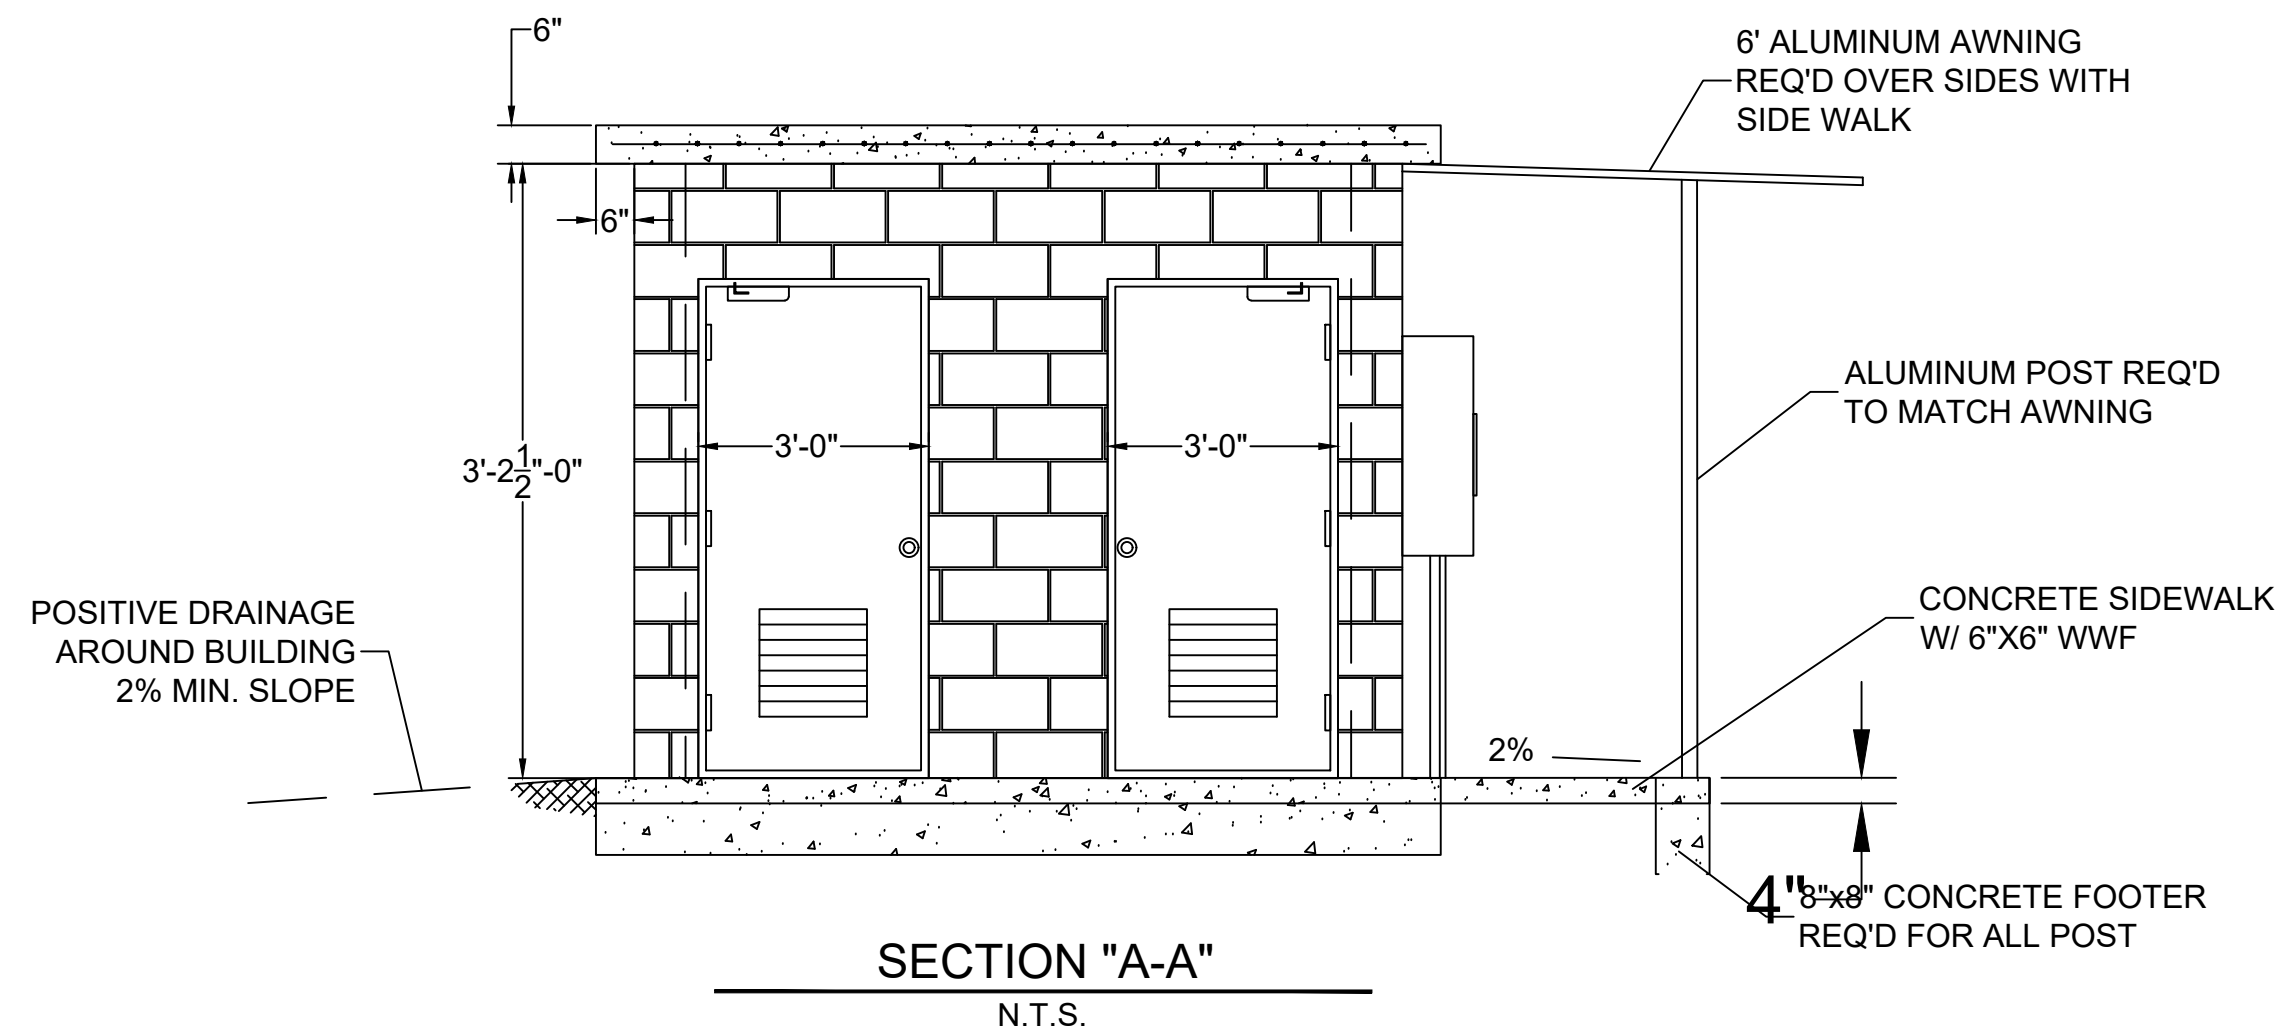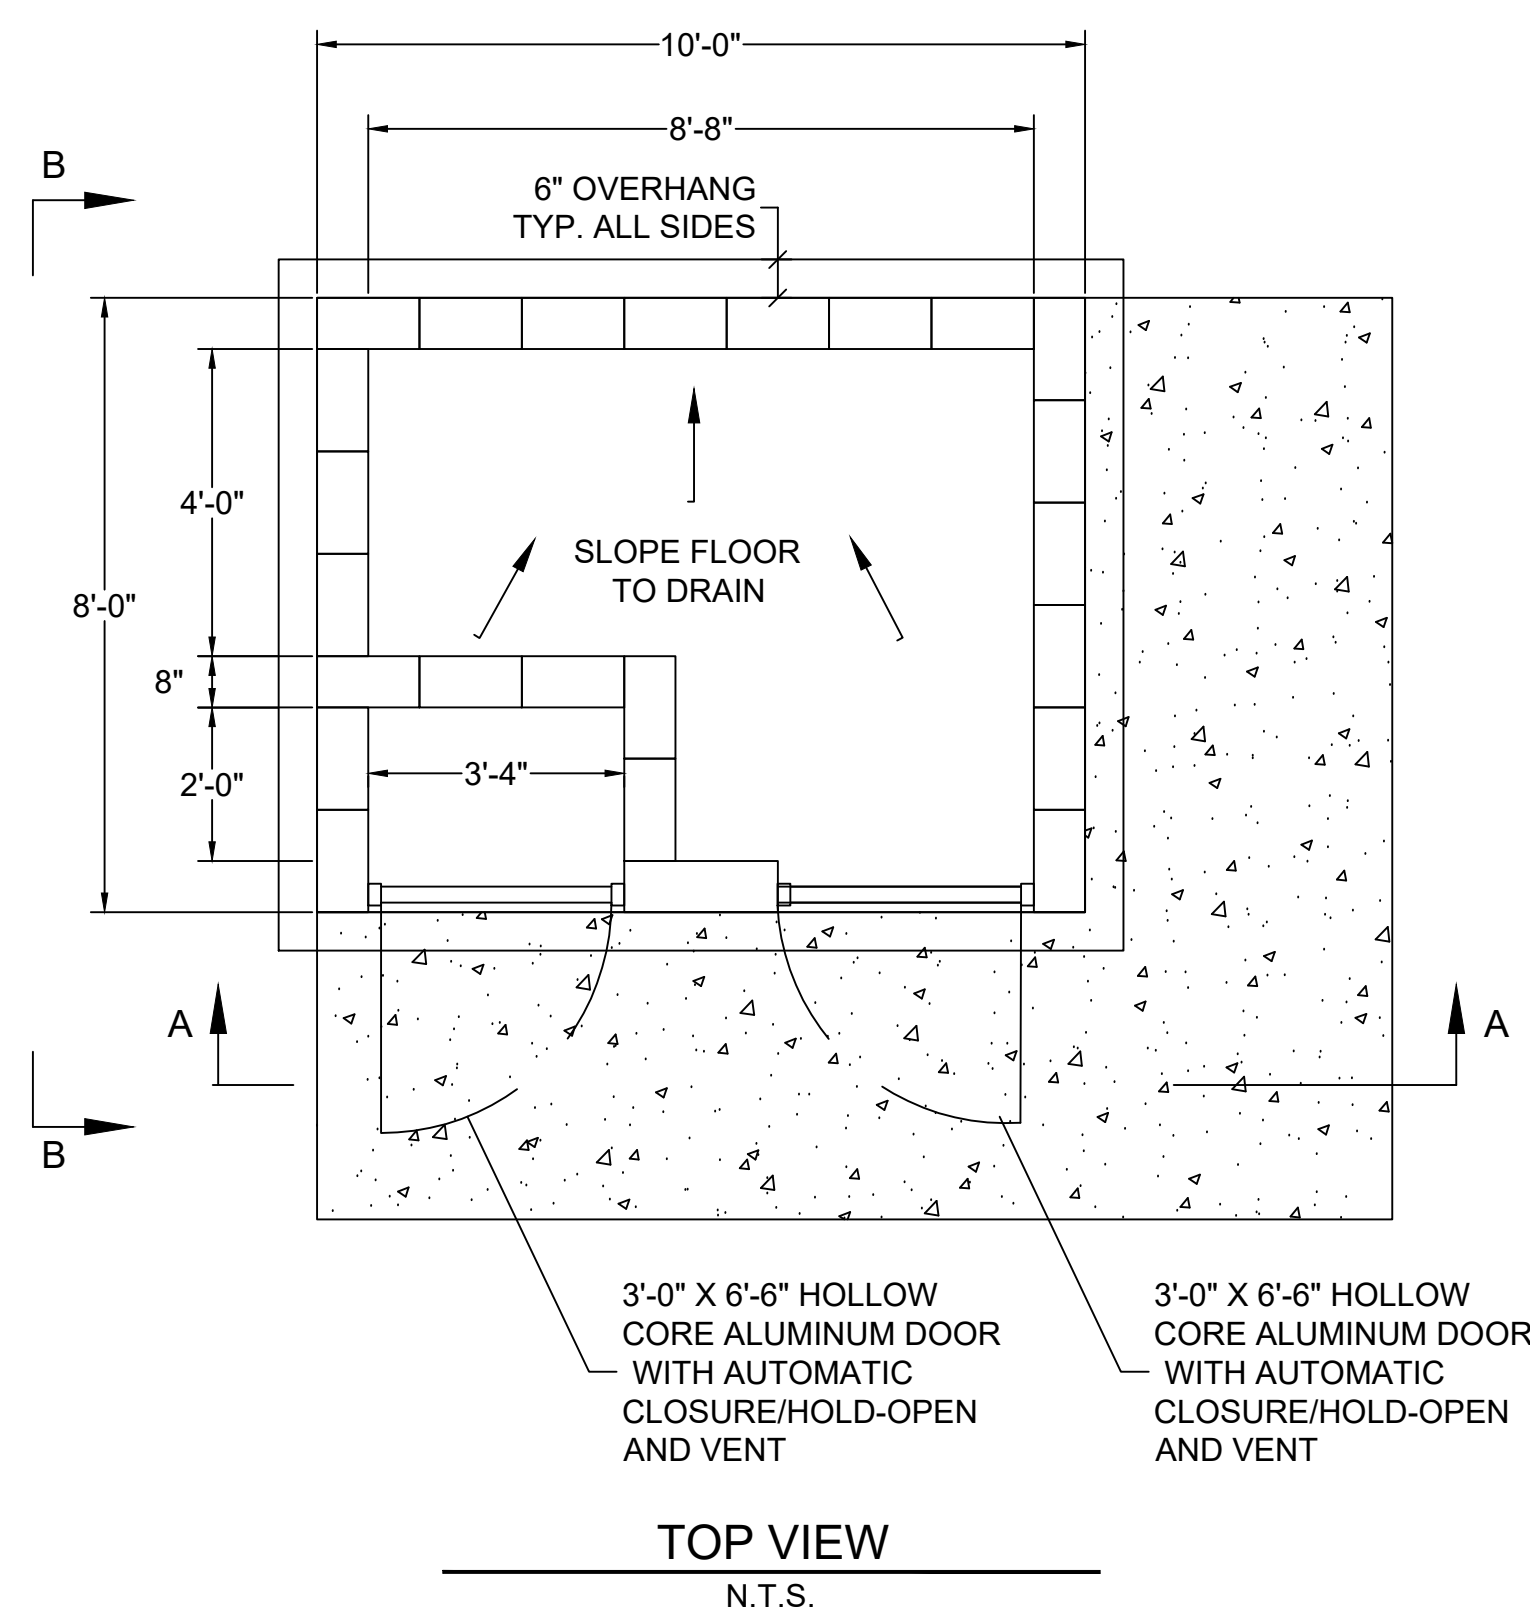


KOSSUTH WATER ASSOCIATION-WENASOGA WELL DETAIL

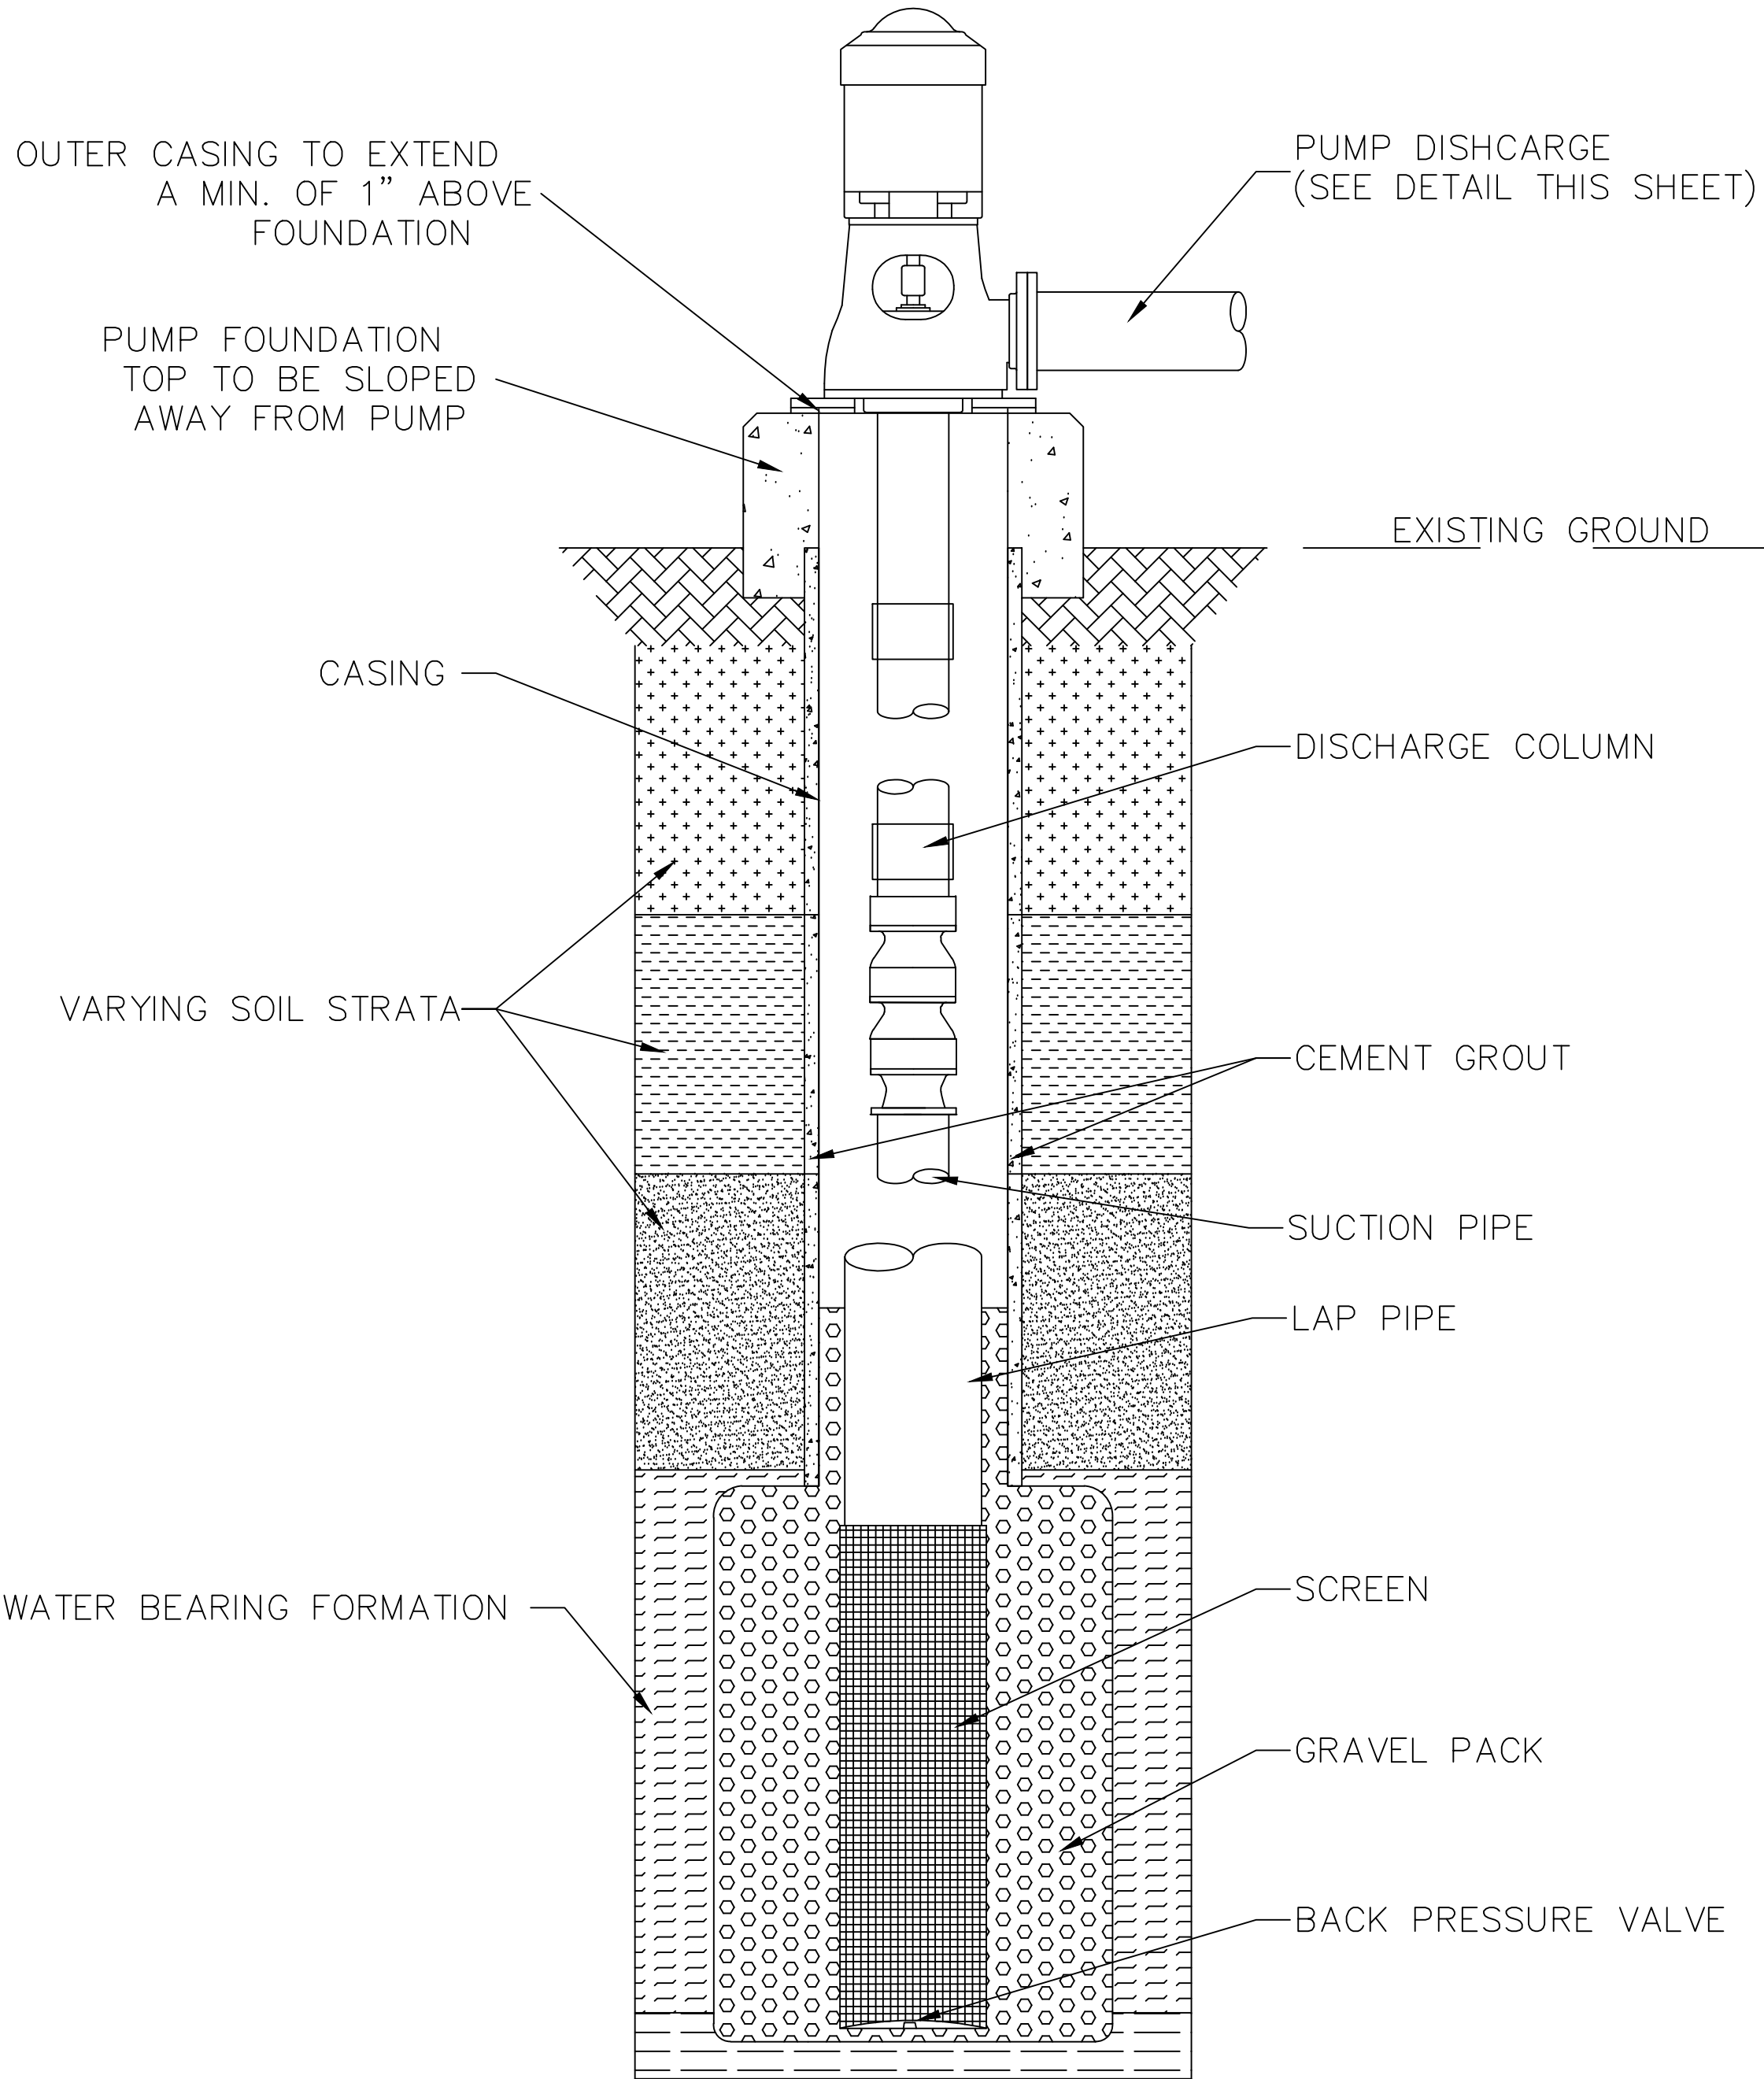

WELL PROFILE
NTS

*SEE WELL DATA SHEET OF THE
TECHNICAL SPECIFICATIONS FOR
MORE DETAIL.

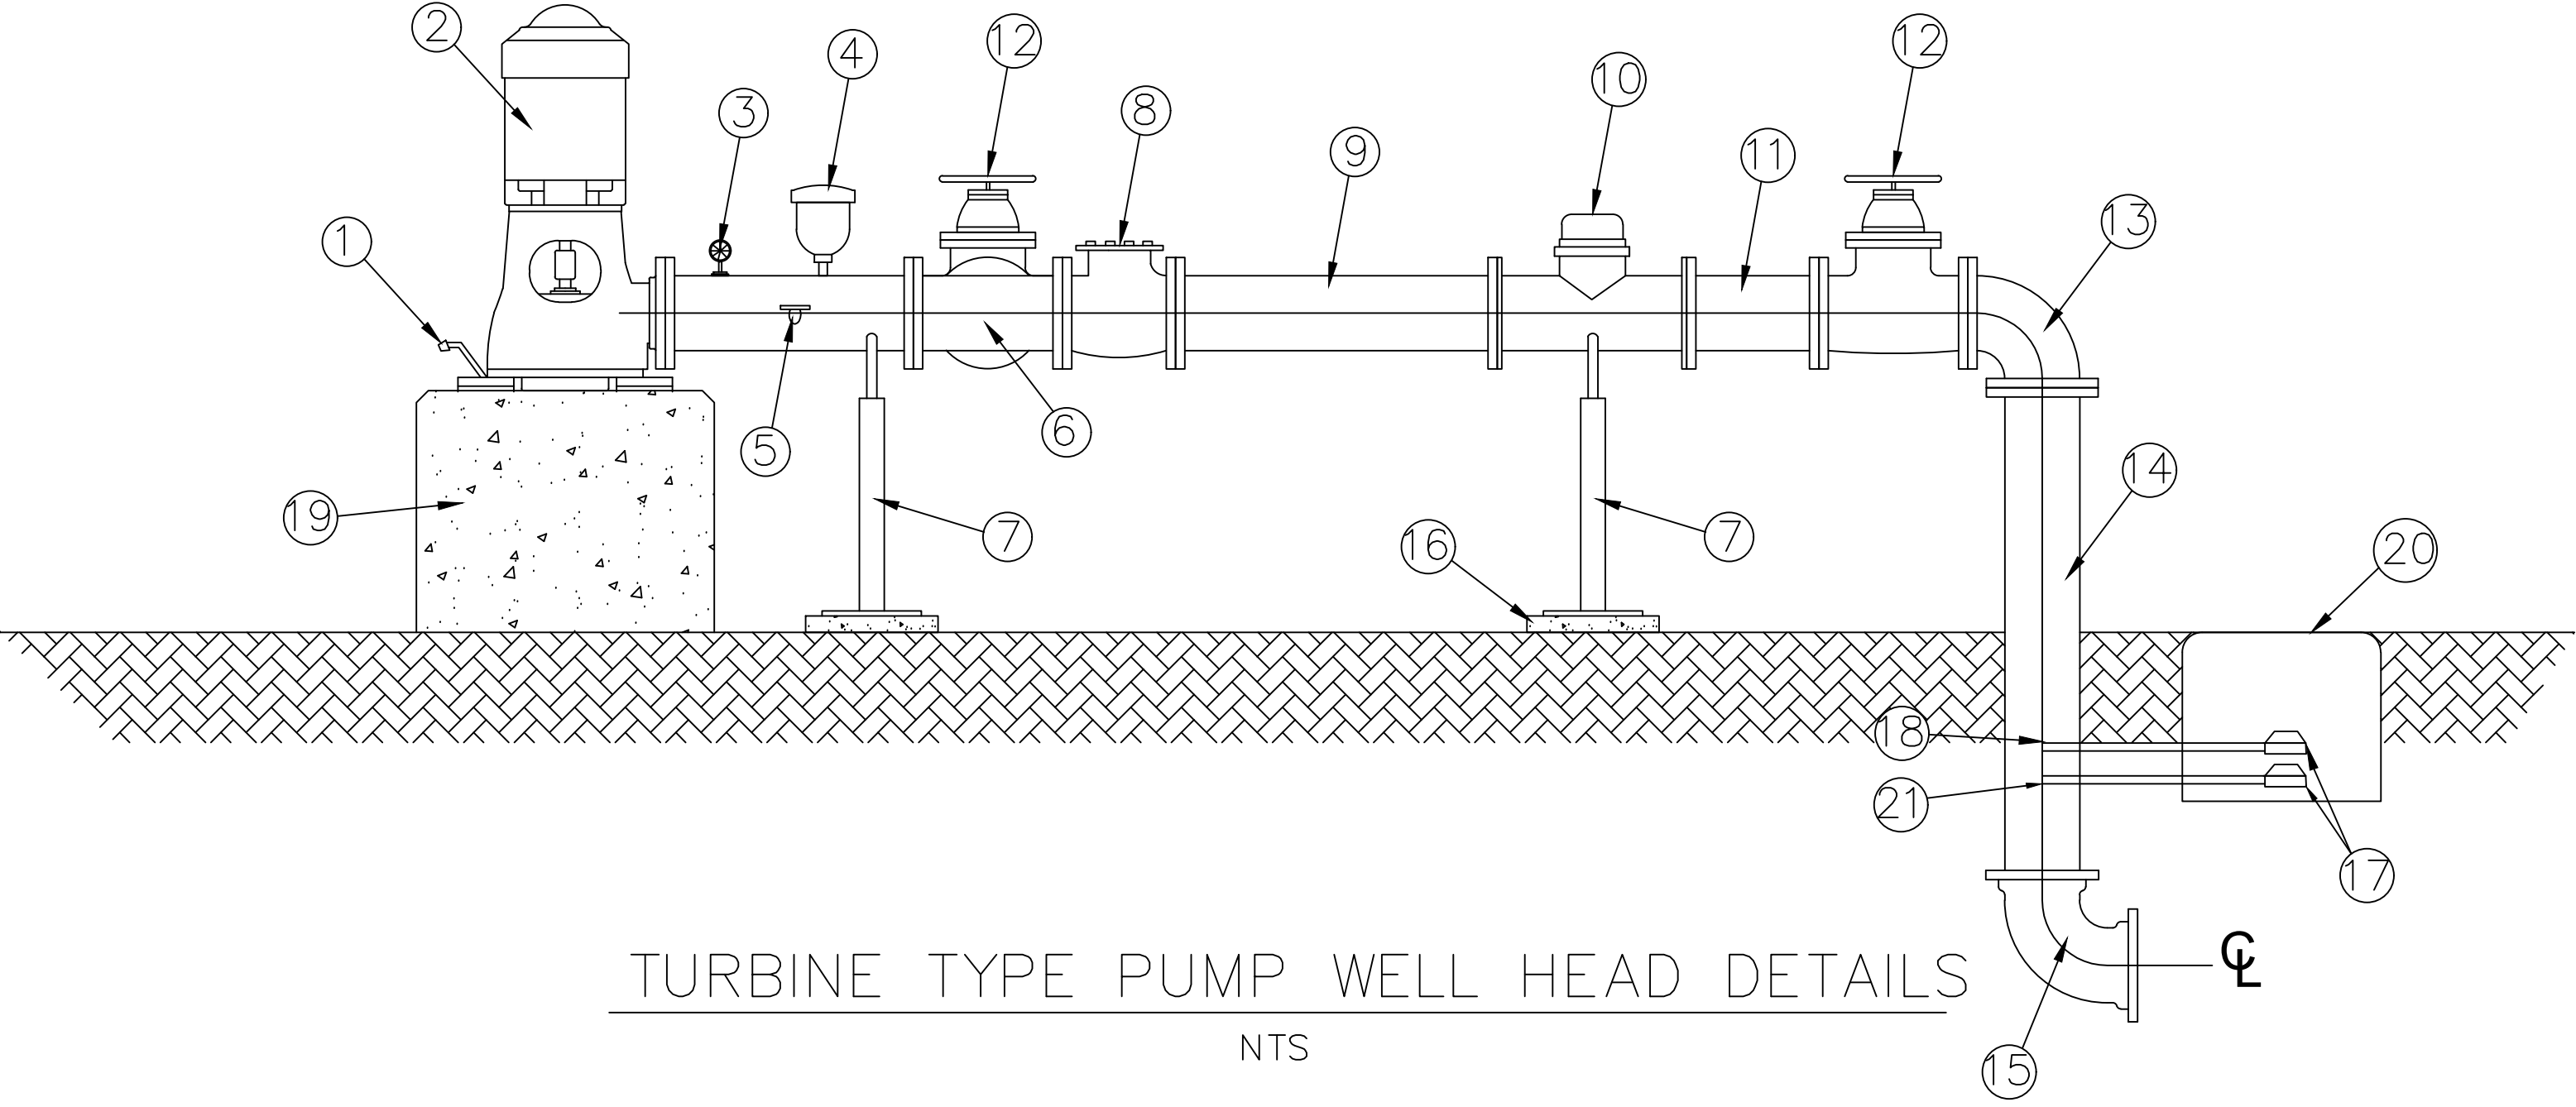

LEGEND		
ID	DESCRIPTION	PLUMBING SIZE 6 IN
1	CASING VENT W/ VENT SCREEN	
2	ELECTRIC MOTOR	
3	PRESSURE GAUGE	
4	AIR RELEASE VALVE W/ VENT SCREEN	
5	SAMPLE FAUCET	
6	FLANGED DI TEE W/ BLIND FLANGE	
7	PIPE SUPPORT	
8	CHECK VALVE	
9	FLANGED DI SPOOL (MIN OF 5 PIPE DIA. IN LENGTH)	
10	MASTER METER "WATER SPECIALTIES ML-04-D" WITH STRAIGHTENING VANES	
11	FLANGED DI SPOOL (MIN OF 2 PIPE DIA. IN LENGTH)	
12	GATE VALVE	
13	90° FLANGED ELBOW	
14	DI SPOOL	
15	90° MJ ELBOW	
16	16"X16"X4" CONCRETE PAD FOR SUPPORTS	
17	BALL VALVE	
18	1" TAP CHLORINE INJECTION	
19	PUMP FOUNDATION	
20	METER BOX FOR BALL VALVES	
21	1/2" TAP PHOSPHATE INJECTION	

SCALE:
N.T.S.

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REVISIONS


IFB: APRIL 22, 2019

PROJECT TITLE:
KOSSUTH WATER ASSOCIATION
WATER SYSTEM IMPROVEMENTS – WENASOGA AREA
CDBG PROJECT NO. 1136-19-225-PF-01

SHEET TITLE:
WELL DETAILS

PROJECT NO.
KWA-19003


SHEET NO.
D-2.0

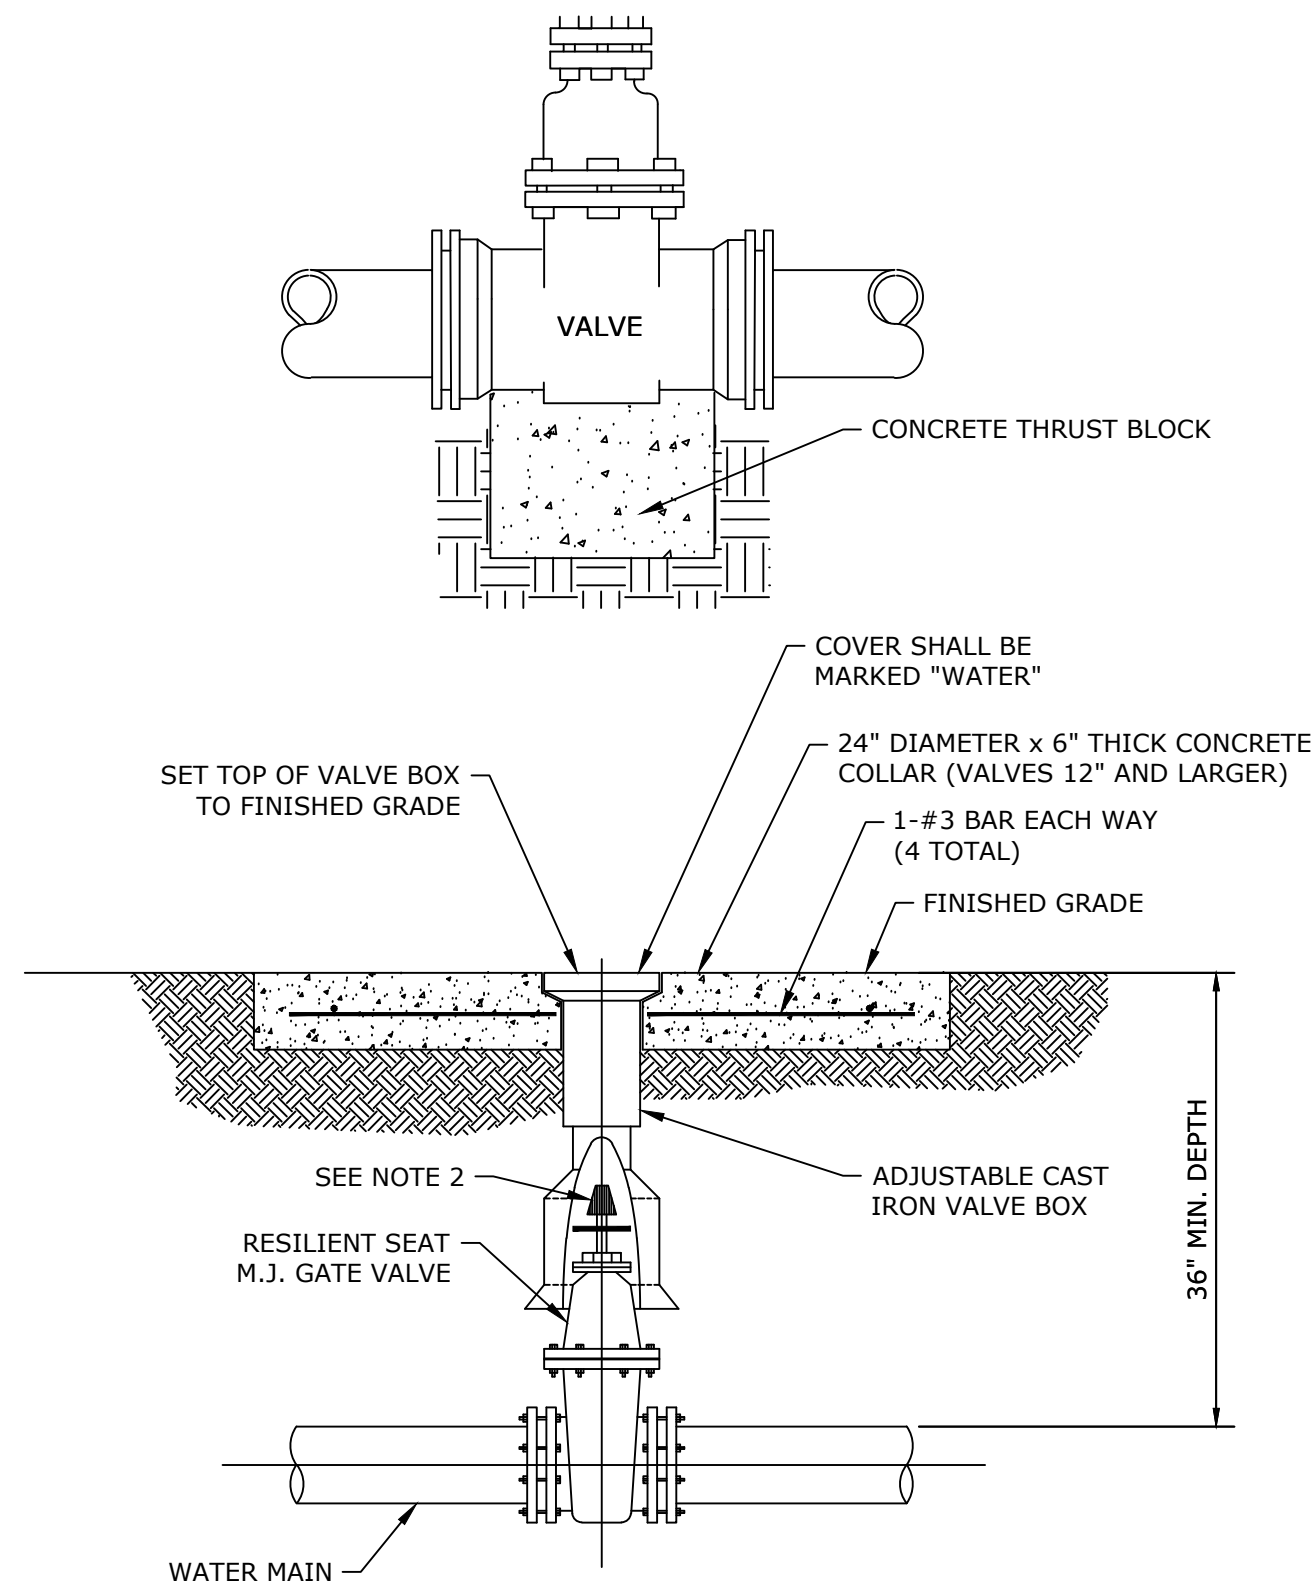

- NOTES:
1. PVC EXTENSIONS SHALL NOT BE USED ON VALVE BOX INSTALLATION.
 2. THE ACTUATING NUT FOR DEEPER VALVES SHALL BE EXTENDED TO COME UP TO 4 FOOT DEPTH BELOW FINISHED GRADE.
 3. DEPENDING ON DEPTH, A 90° OPERATOR MAY BE REQUIRED.

WATER MAIN GATE VALVE AND BOX DETAIL

SCALE: NOT TO SCALE

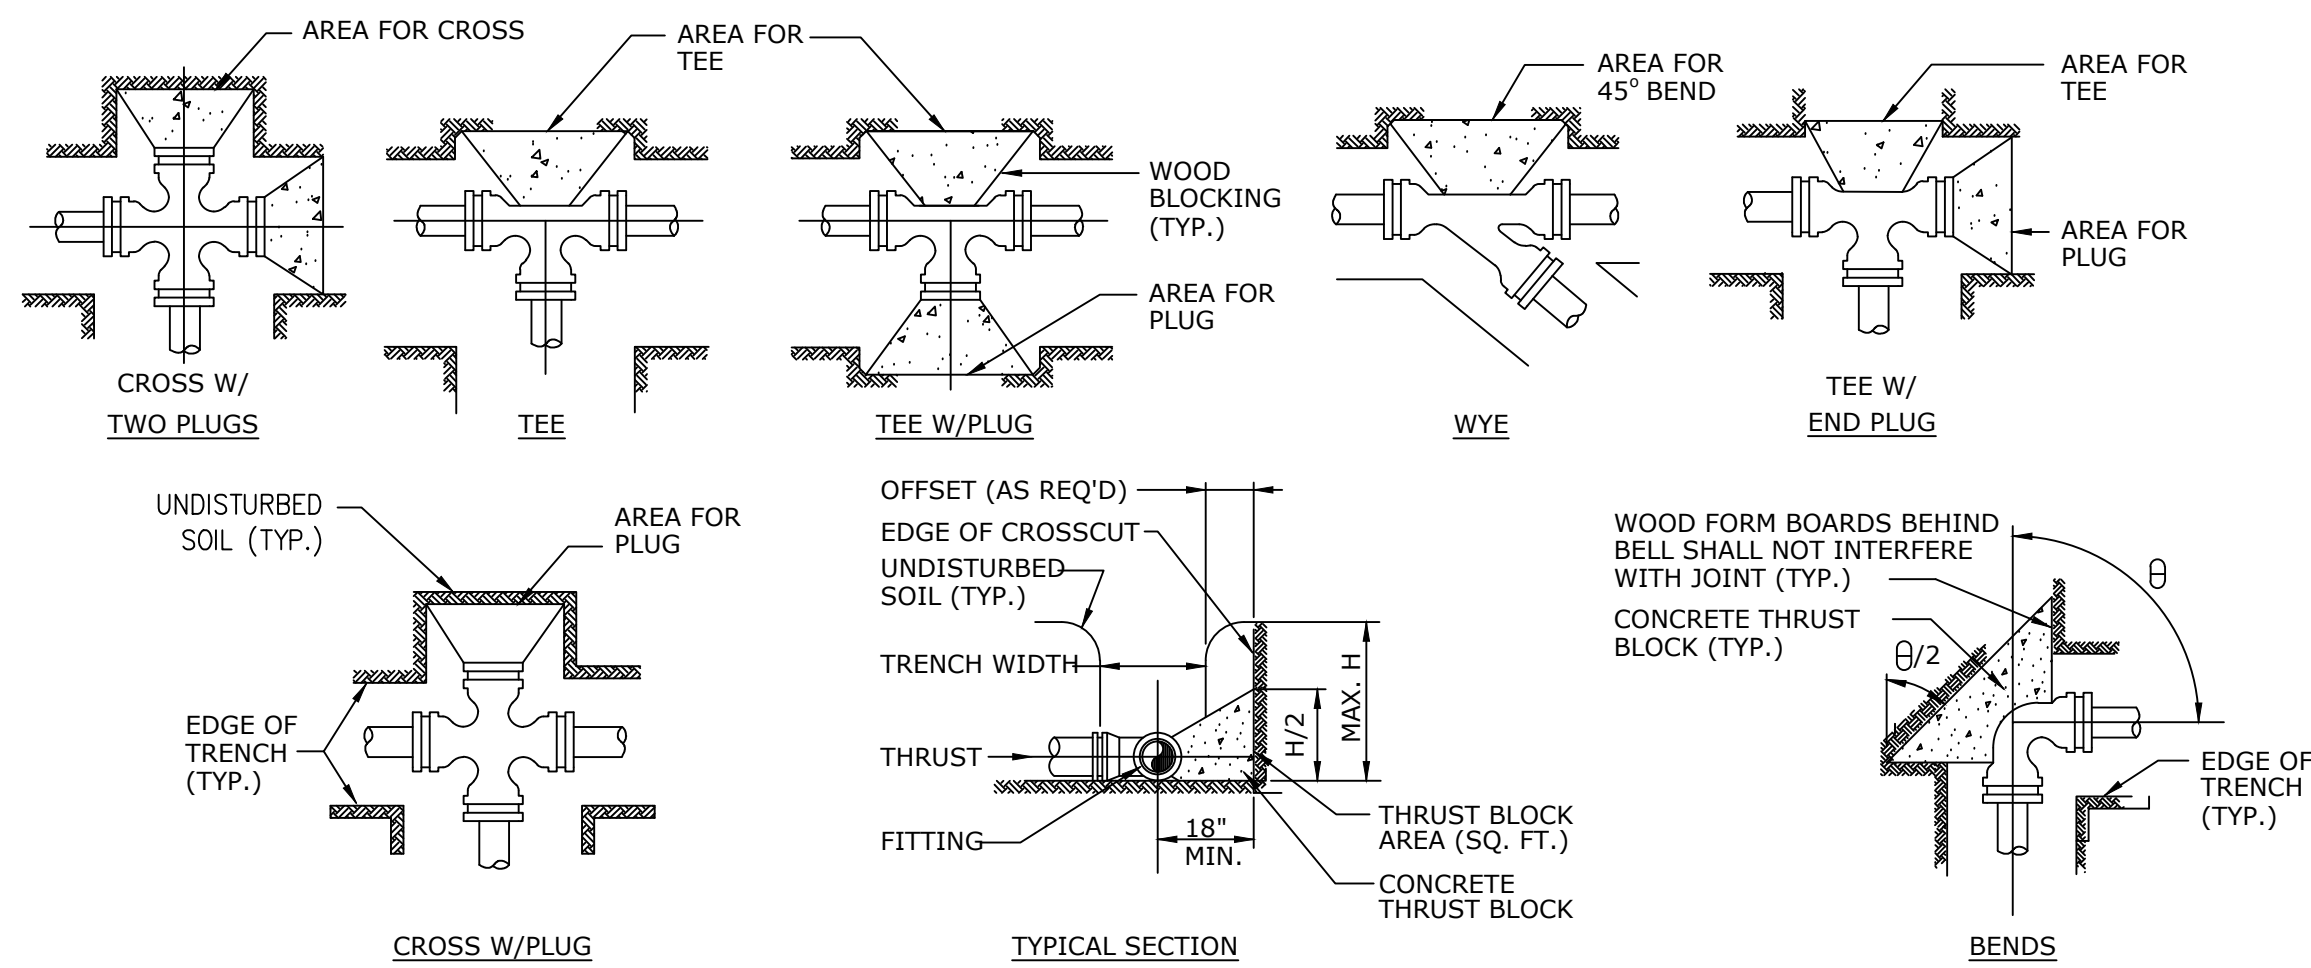


SCHEDULE FOR THRUST BLOCK AREAS									
PIPE SIZE (INCHES)	90 BEND (SQ FT)	45 BEND (SQ FT)	22-1/2 BEND (SQ FT)	11-1/4 BEND (SQ FT)	TEE & PLUG (SQ FT)	CROSS (SQ FT)	WYE (SQ FT)	DESIGN PRESS (PSI)	
4	3.5	1.9	1.0	1.0	2.5	3.7	5.3	100	150
6	6.1	3.3	1.7	1.0	4.3	6.4	9.1	100	150
8	9.1	4.9	2.5	1.3	6.5	9.7	13.7	100	150
10	12.9	7.0	3.6	1.8	9.1	13.7	19.4	100	150
12	19.4	10.5	5.3	2.7	13.7	19.4	27.4	100	150
16	21.0	11.4	5.8	2.9	14.9			100	150
18								100	150
20	34.5	18.7	9.5	4.8	24.4			100	150
24								100	150

THRUST BLOCK DETAIL

SCALE: NOT TO SCALE


- CHAIN LINK FENCING NOTES:**
1. 2" WIRE MESH SHALL BE No. 9 GAUGE 2.0 oz. HOT DIPPED GALVANIZED STEEL AFTER WEAVING WITH TOP AND BOTTOM SELVAGES TWISTED AND BARBED.
 2. ALL STEEL FRAMEWORK AND APPURTENANCES SHALL BE 2.0 oz. HOT DIPPED GALVANIZED.
 3. 3 STRANDS OF BARB WIRE SHALL BE 12 GAUGE STEEL WIRE WITH 4 POINT BARBS ON 5" CENTERS, WIRE TO HAVE 0.40 oz. ALUMINUM ALLOY COATING PER SQUARE FOOT.
 4. CORNER & BRACE POST SHALL BE 3-1/2" HOT DIPPED GALVANIZED STEEL PIPE WEIGHING 9.11 LBS. PER LINEAR FOOT.
 5. LINE POST SHALL BE 2-1/2" HOT DIPPED GALVANIZED STEEL PIPE WEIGHING 5.79 LBS. PER LINEAR FOOT.
 6. GATE POST SHALL BE 4" HOT DIPPED GALVANIZED STEEL PIPE WEIGHING 10.79 LBS. PER LINEAR FOOT.
 7. GATE FRAME SHALL BE 1-1/2" HOT DIPPED GALVANIZED STEEL PIPE WEIGHING 2.72 LBS. PER LINEAR FOOT.
 8. TOP RAILS & POST BRACE ASSEMBLIES SHALL BE 1-1/2" HOT DIPPED GALVANIZED STEEL PIPE WEIGHING 2.72 LBS. PER LINEAR FOOT.
 9. TENSION WIRE SHALL BE No. 7 GAUGE ALUMINIZED STEEL WIRE, SINGLE STRAND AT BOTTOM OF FABRIC.
 10. POSTS SHALL BE INSTALLED AT A MAXIMUM SPACING OF 10' ON CENTERS.

TOP RAIL SHALL BE 1-1/2" SCH. 40 GALV. STEEL CONTINUOUS THROUGH LINE POSTS

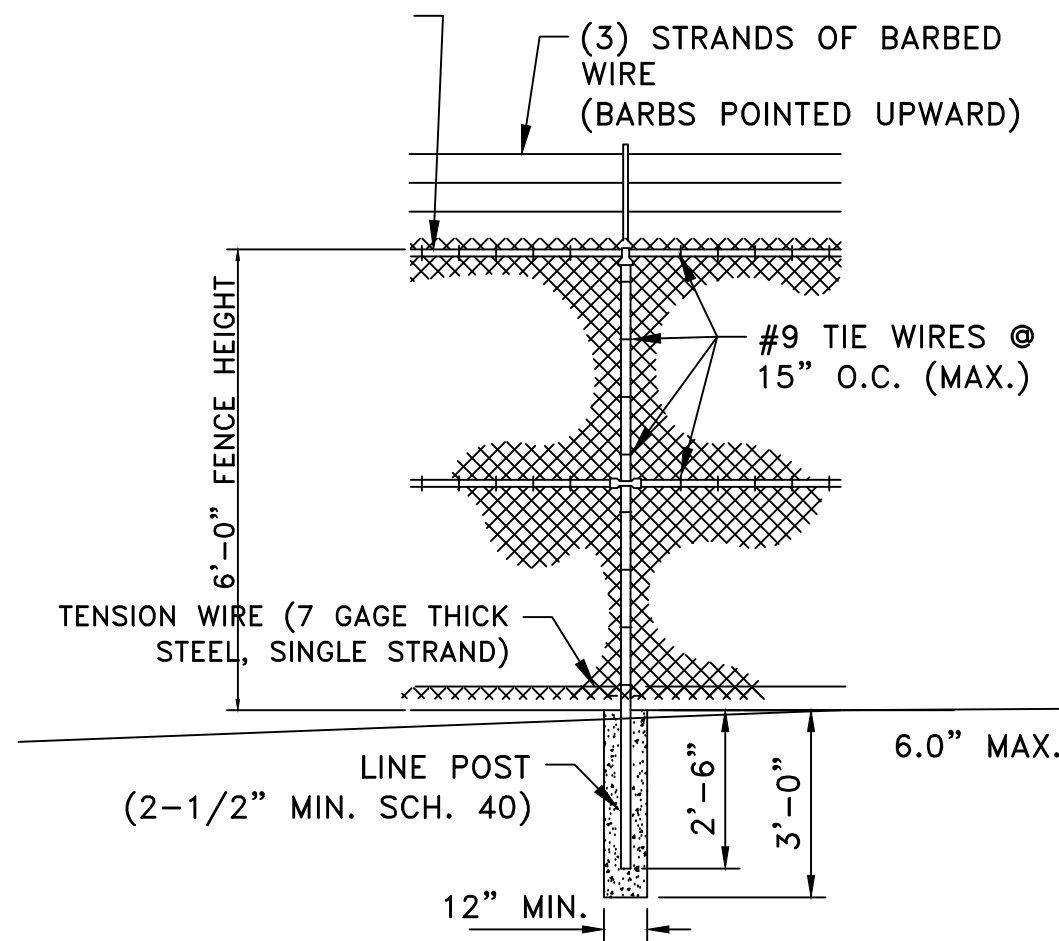


FENCE LINE POST

SCALE: NOT TO SCALE

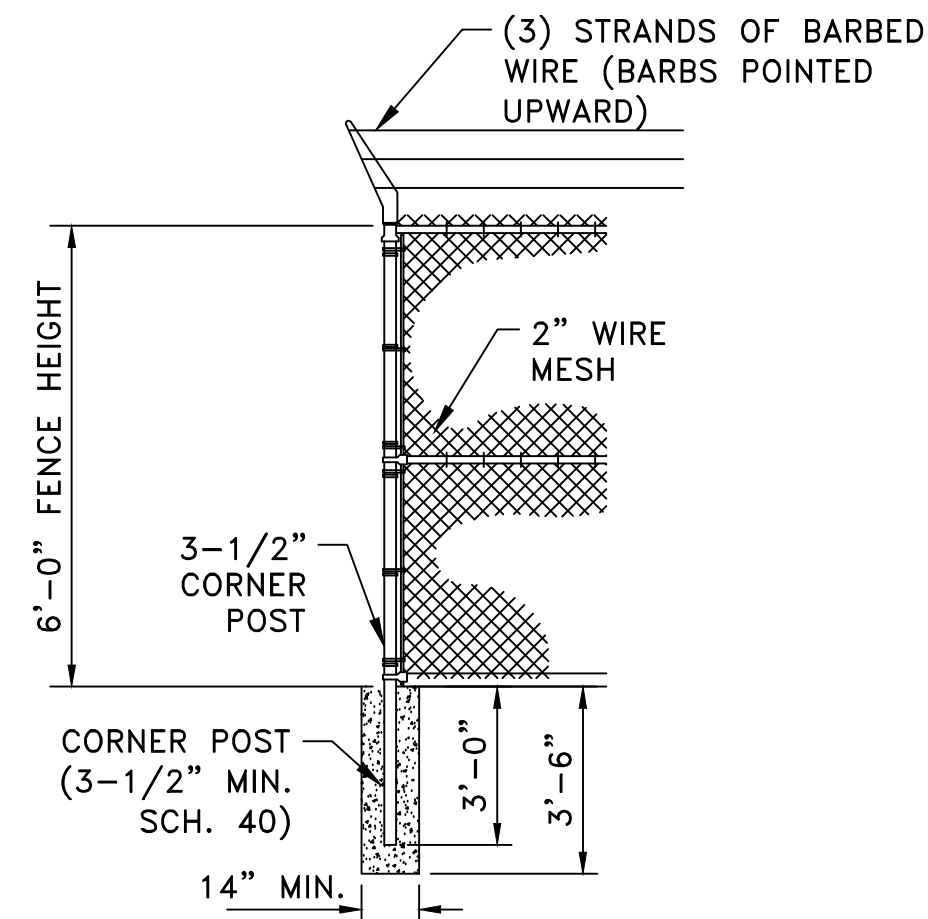


FENCE BRACE POST

SCALE: NOT TO SCALE

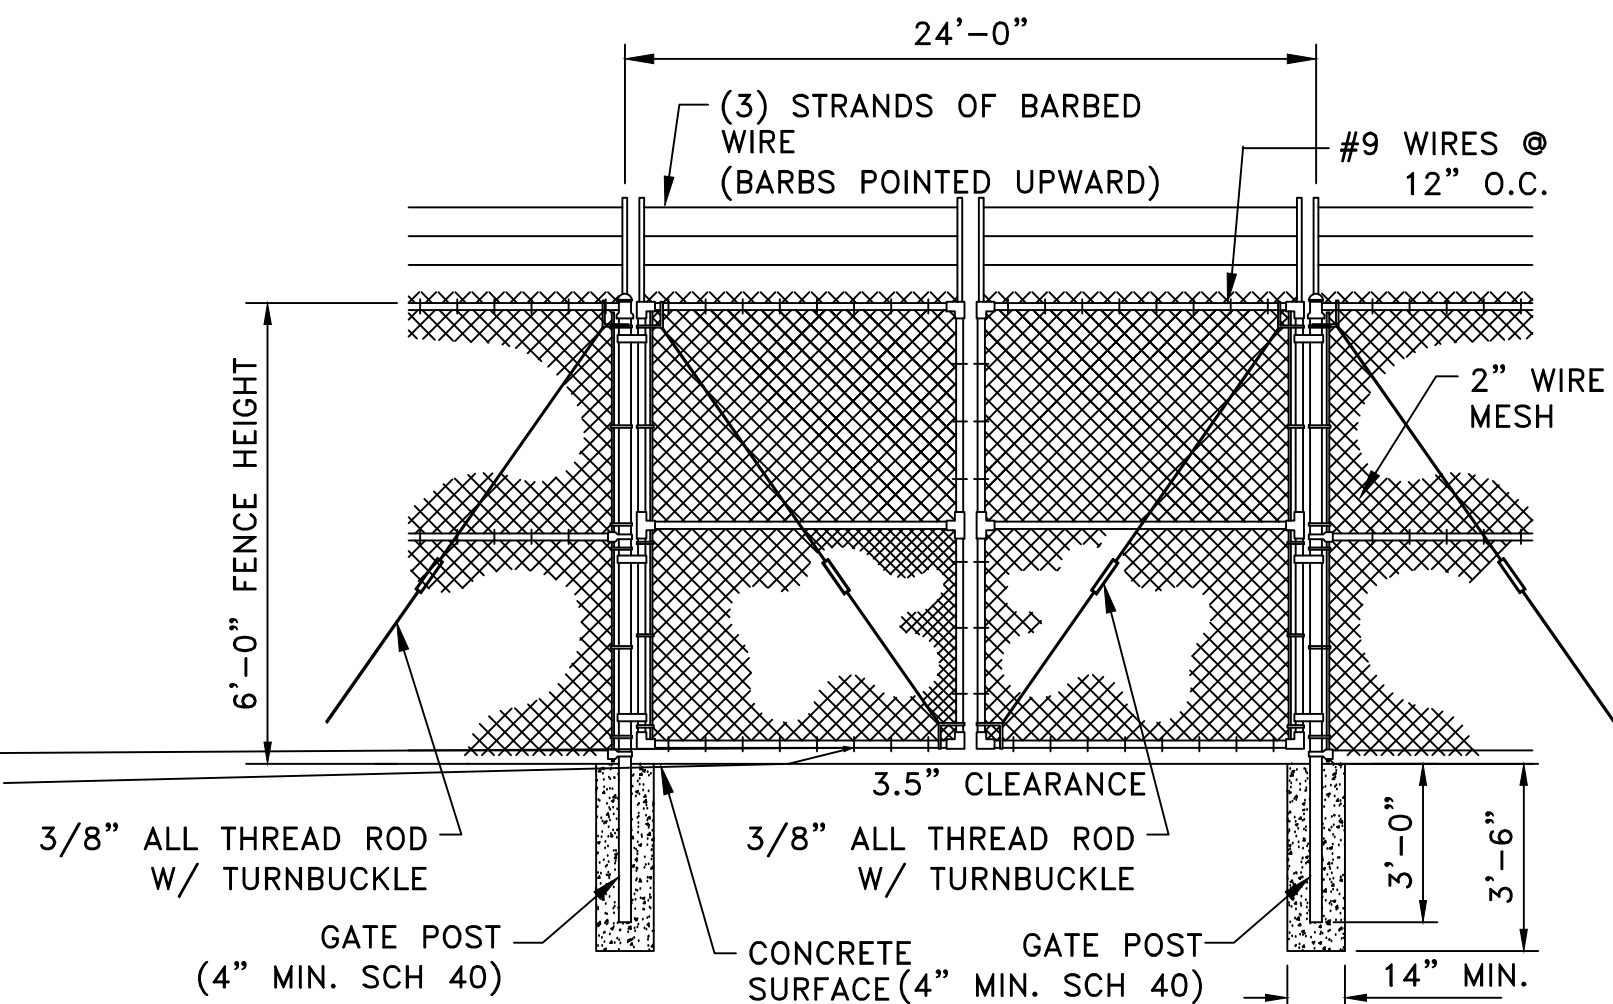


DRIVEWAY GATE DETAIL

SCALE: NOT TO SCALE

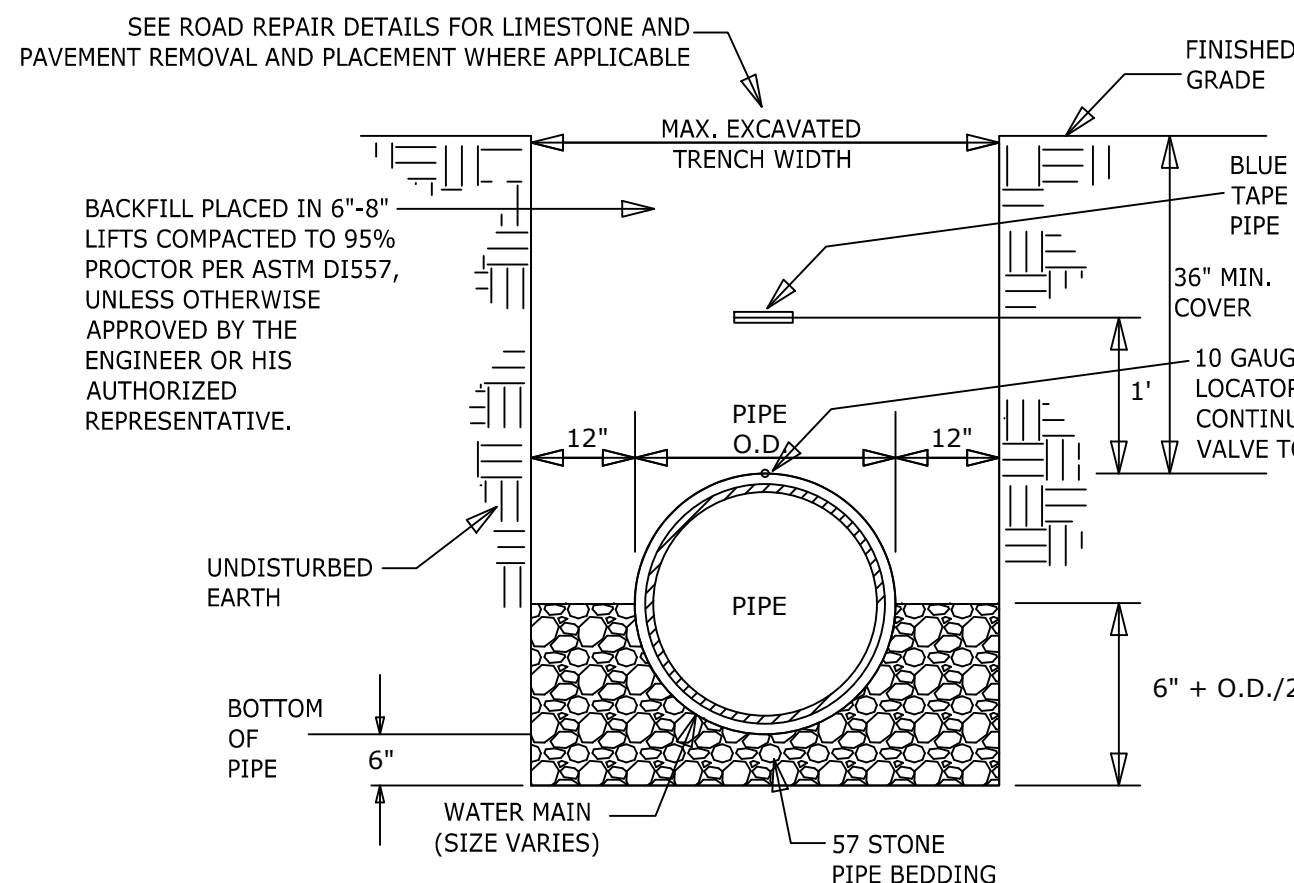

WATER PIPE PLACEMENT NOTES:

1. WATER PIPE SHALL BE PVC OR DUCTILE IRON (D.I.) IN ACCORDANCE WITH THE SPECIFICATION. LOCATION FOR INSTALLATION OF PVC OR D.I. PIPE SHALL BE AS SHOWN ON THE DRAWINGS OR AS DIRECTED BY THE ENGINEER OR HIS AUTHORIZED REPRESENTATIVE.
2. BACKFILL MATERIAL SHALL BE PLACED ON BOTH SIDES OF PIPE SIMULTANEOUSLY DURING BACKFILLING OPERATIONS TO PREVENT SHIFTING OR DAMAGE TO PIPE.

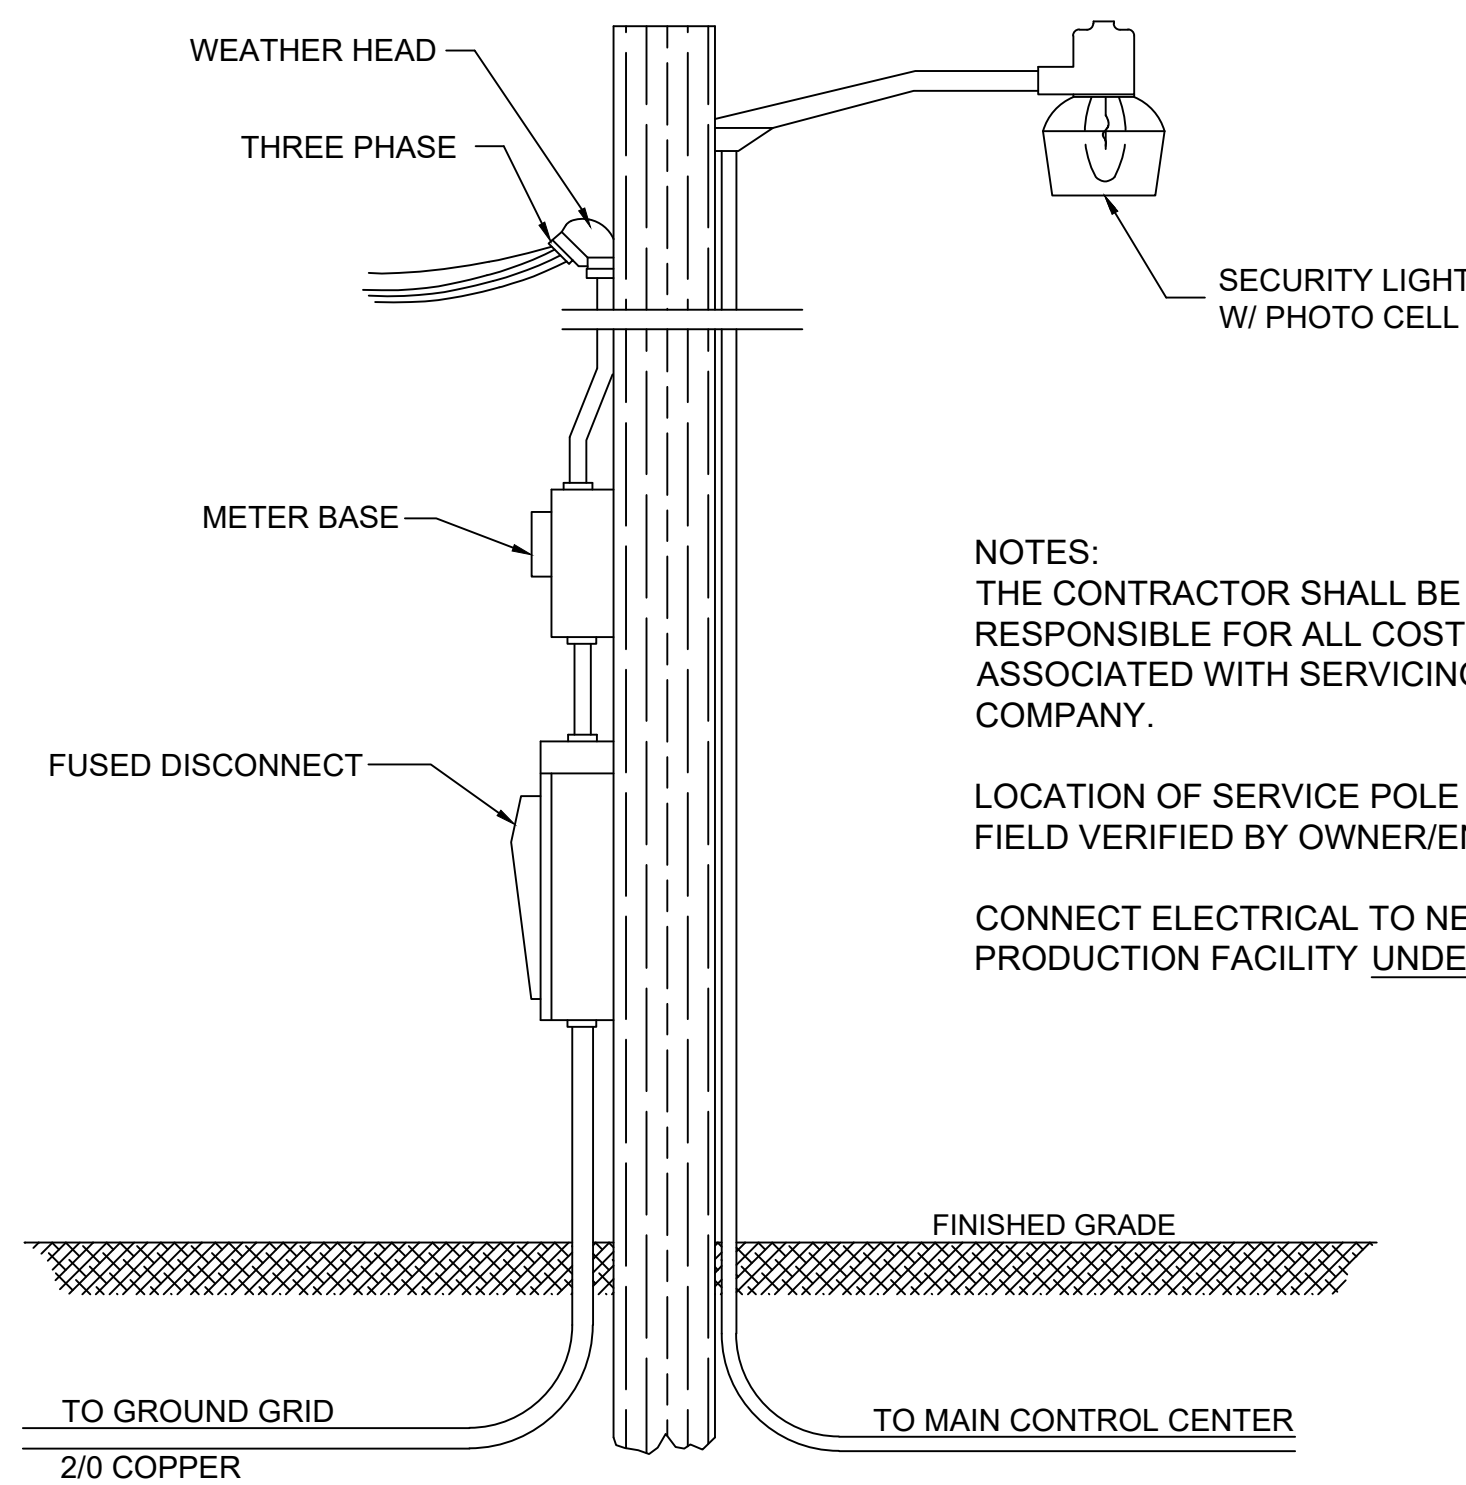

SERVICE POLE DETAIL

SCALE: NOT TO SCALE

- NOTES:
- THE CONTRACTOR SHALL BE RESPONSIBLE FOR ALL COSTS ASSOCIATED WITH SERVICING POWER COMPANY.
- LOCATION OF SERVICE POLE SHALL BE FIELD VERIFIED BY OWNER/ENGINEER.
- CONNECT ELECTRICAL TO NEW PRODUCTION FACILITY UNDERGROUND

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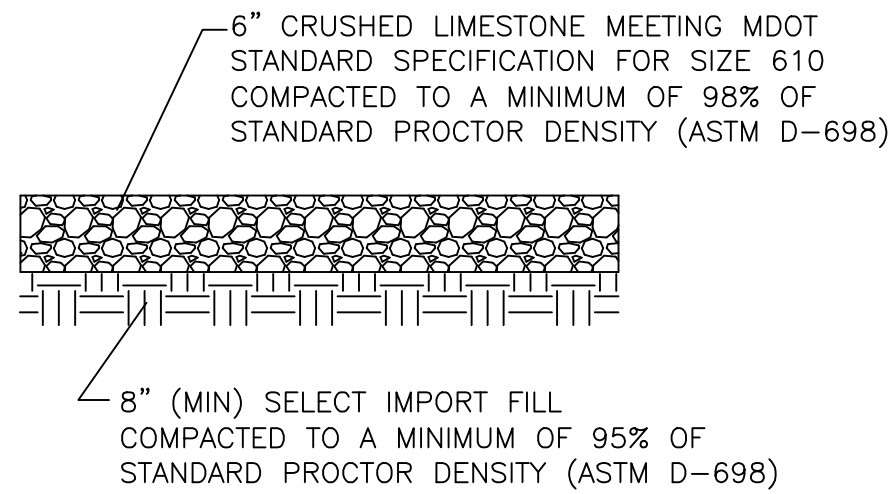
PROJECT TITLE:
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SHEET TITLE:
MISCELLANEOUS DETAILS

PROJECT NO.
KWA-19003

SHEET NO.


D-3.0



TYPICAL SECTION

GRANULAR MATERIAL
(610 CRUSHED STONE) PAVING

SCALE: NOT TO SCALE

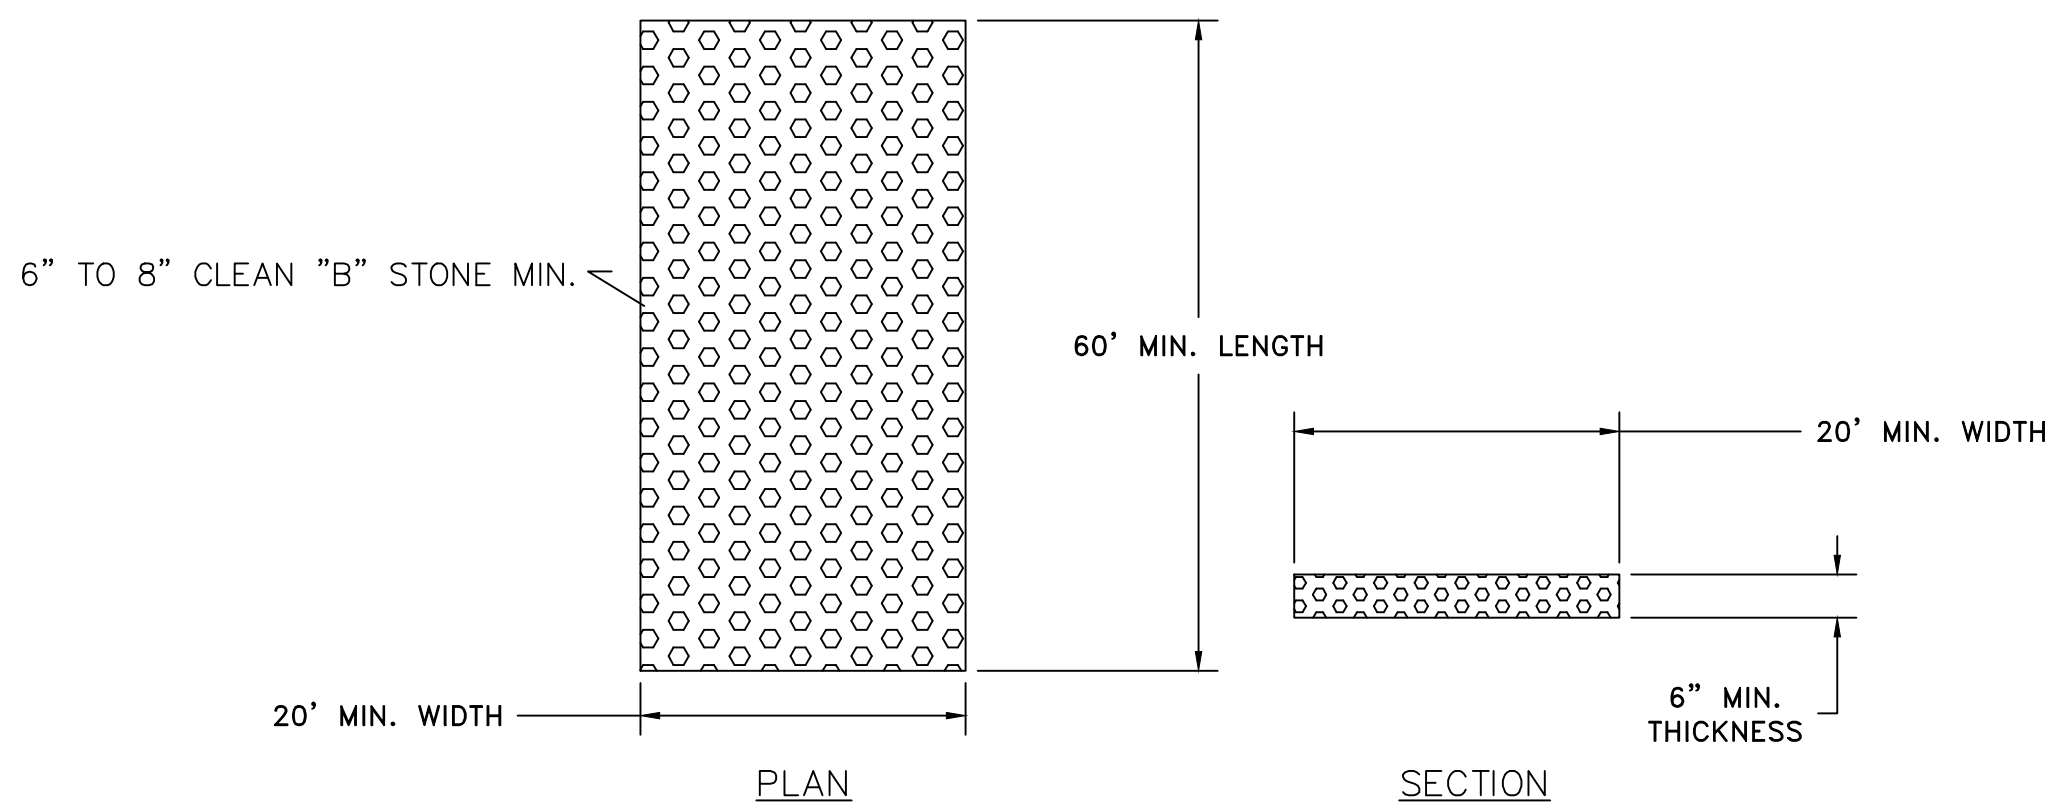


DETAIL #2 GRAVEL CONSTRUCTION ENTRANCE

SCALE: NOT TO SCALE

NOTES:



- 1.) THE MAXIMUM HEIGHT OF THE CHECK DAM IS 2 FEET.
- 2.) CHECK DAM CENTER MUST BE BE 6 INCHES LOWER THAN OUTER EDGES.
- 3.) THE MAXIMUM SPACING BETWEEN DAMS SHOULD BE SUCH THAT THE TOE OF THE UPSTREAM DAM IS AT THE SAME AT THE SAME ELEVATION AS THE TOP OF THE DOWNSTREAM DAM.
- 4.) ACCUMULATED SEDIMENT IS TO BE REMOVED FROM BEHIND CHECKDAMS WHEN IT REACHES ONE HALF THE DAM HEIGHT.

- 5.) EROSION AROUND DAM EDGES IS TO BE CORRECTED CORRECTED IMMEDIATELY.

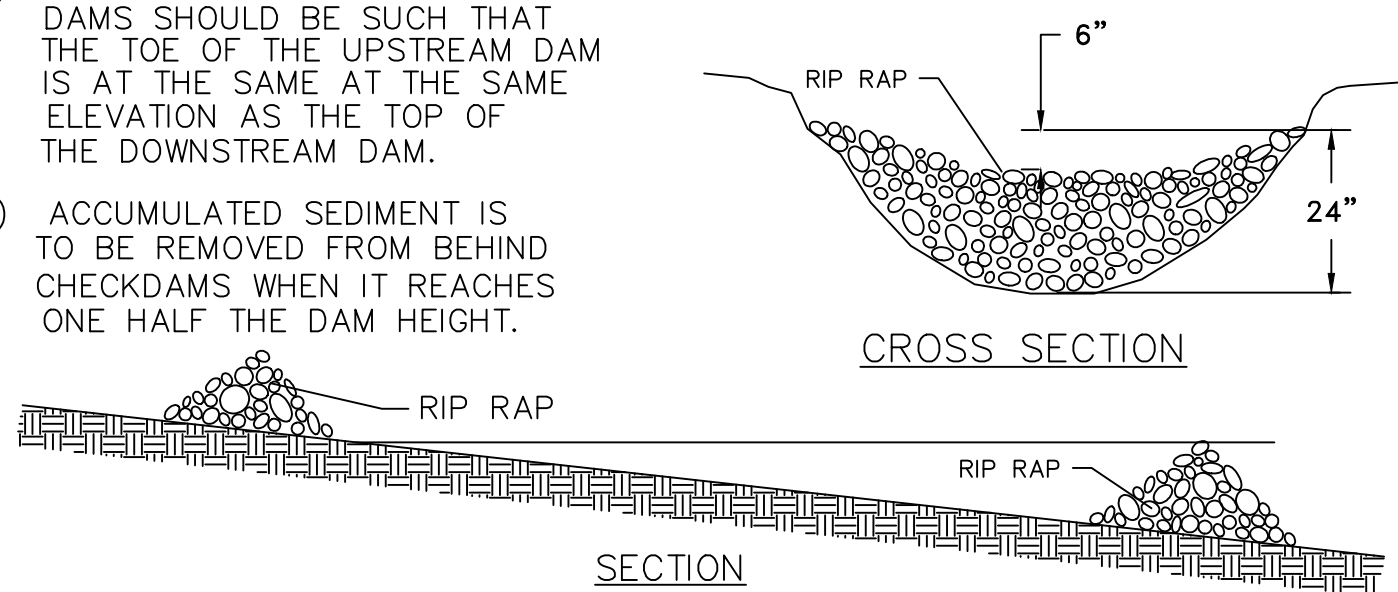

DETAIL #1 CHECK DAM

SCALE: NOT TO SCALE

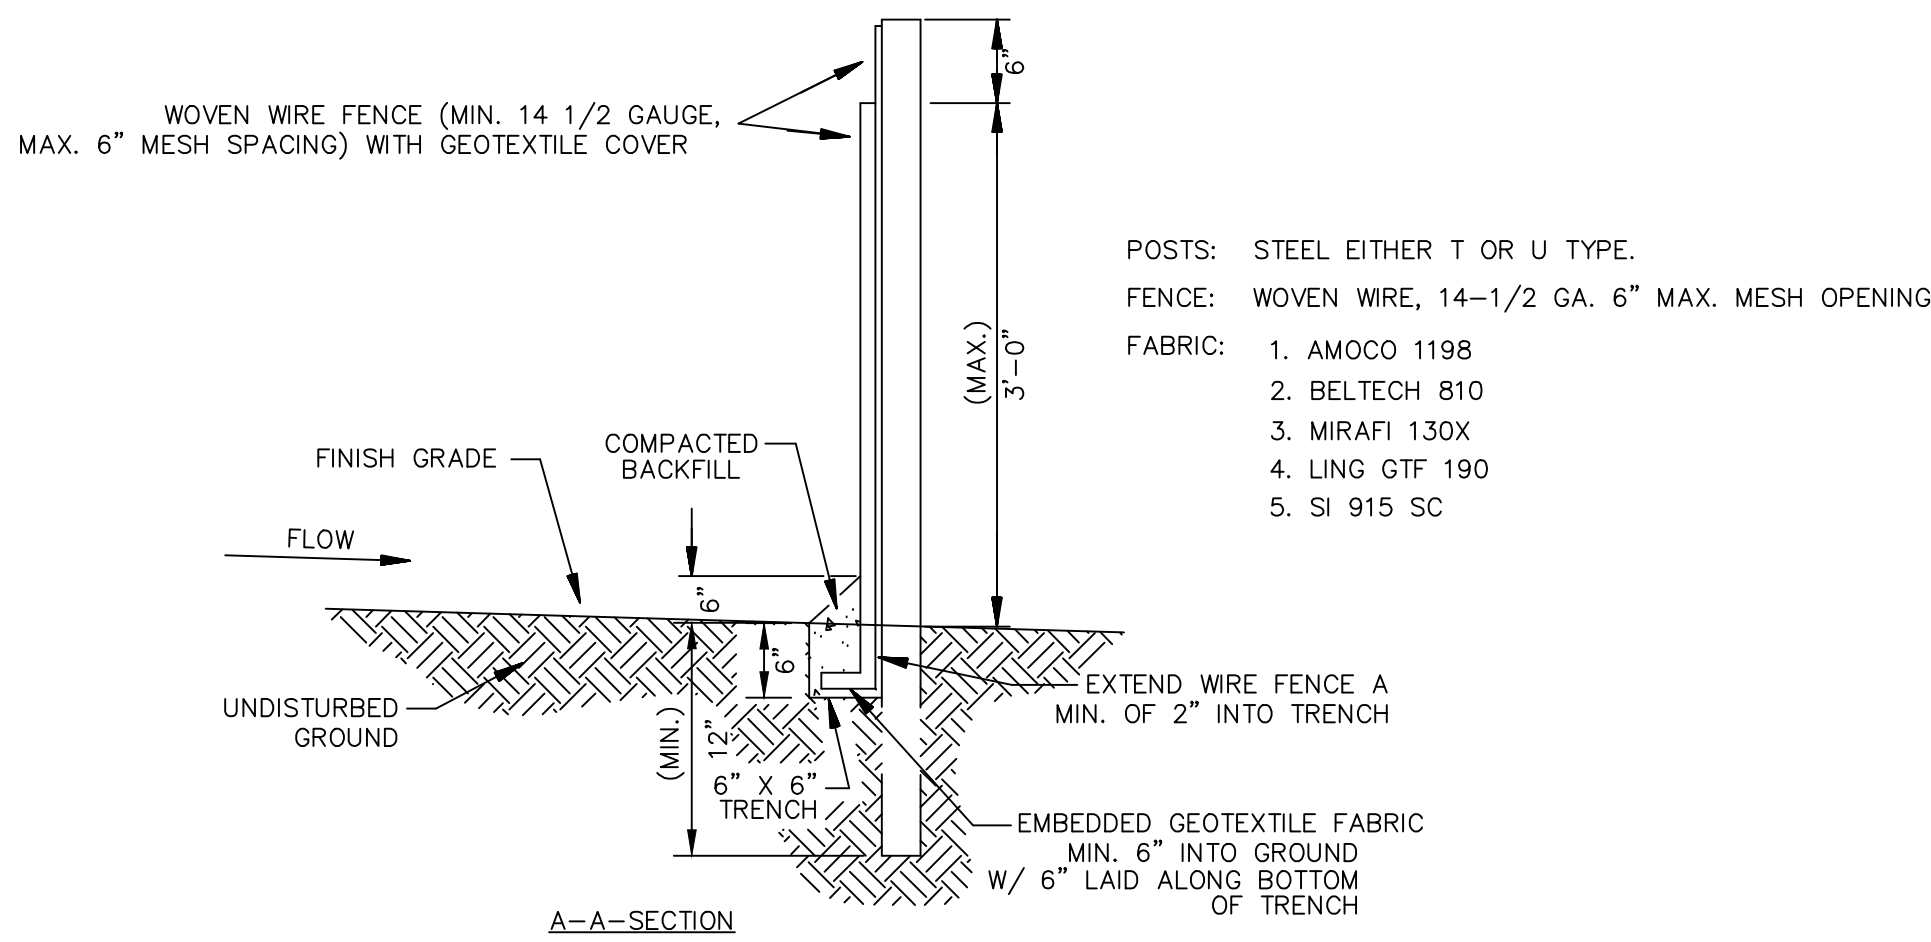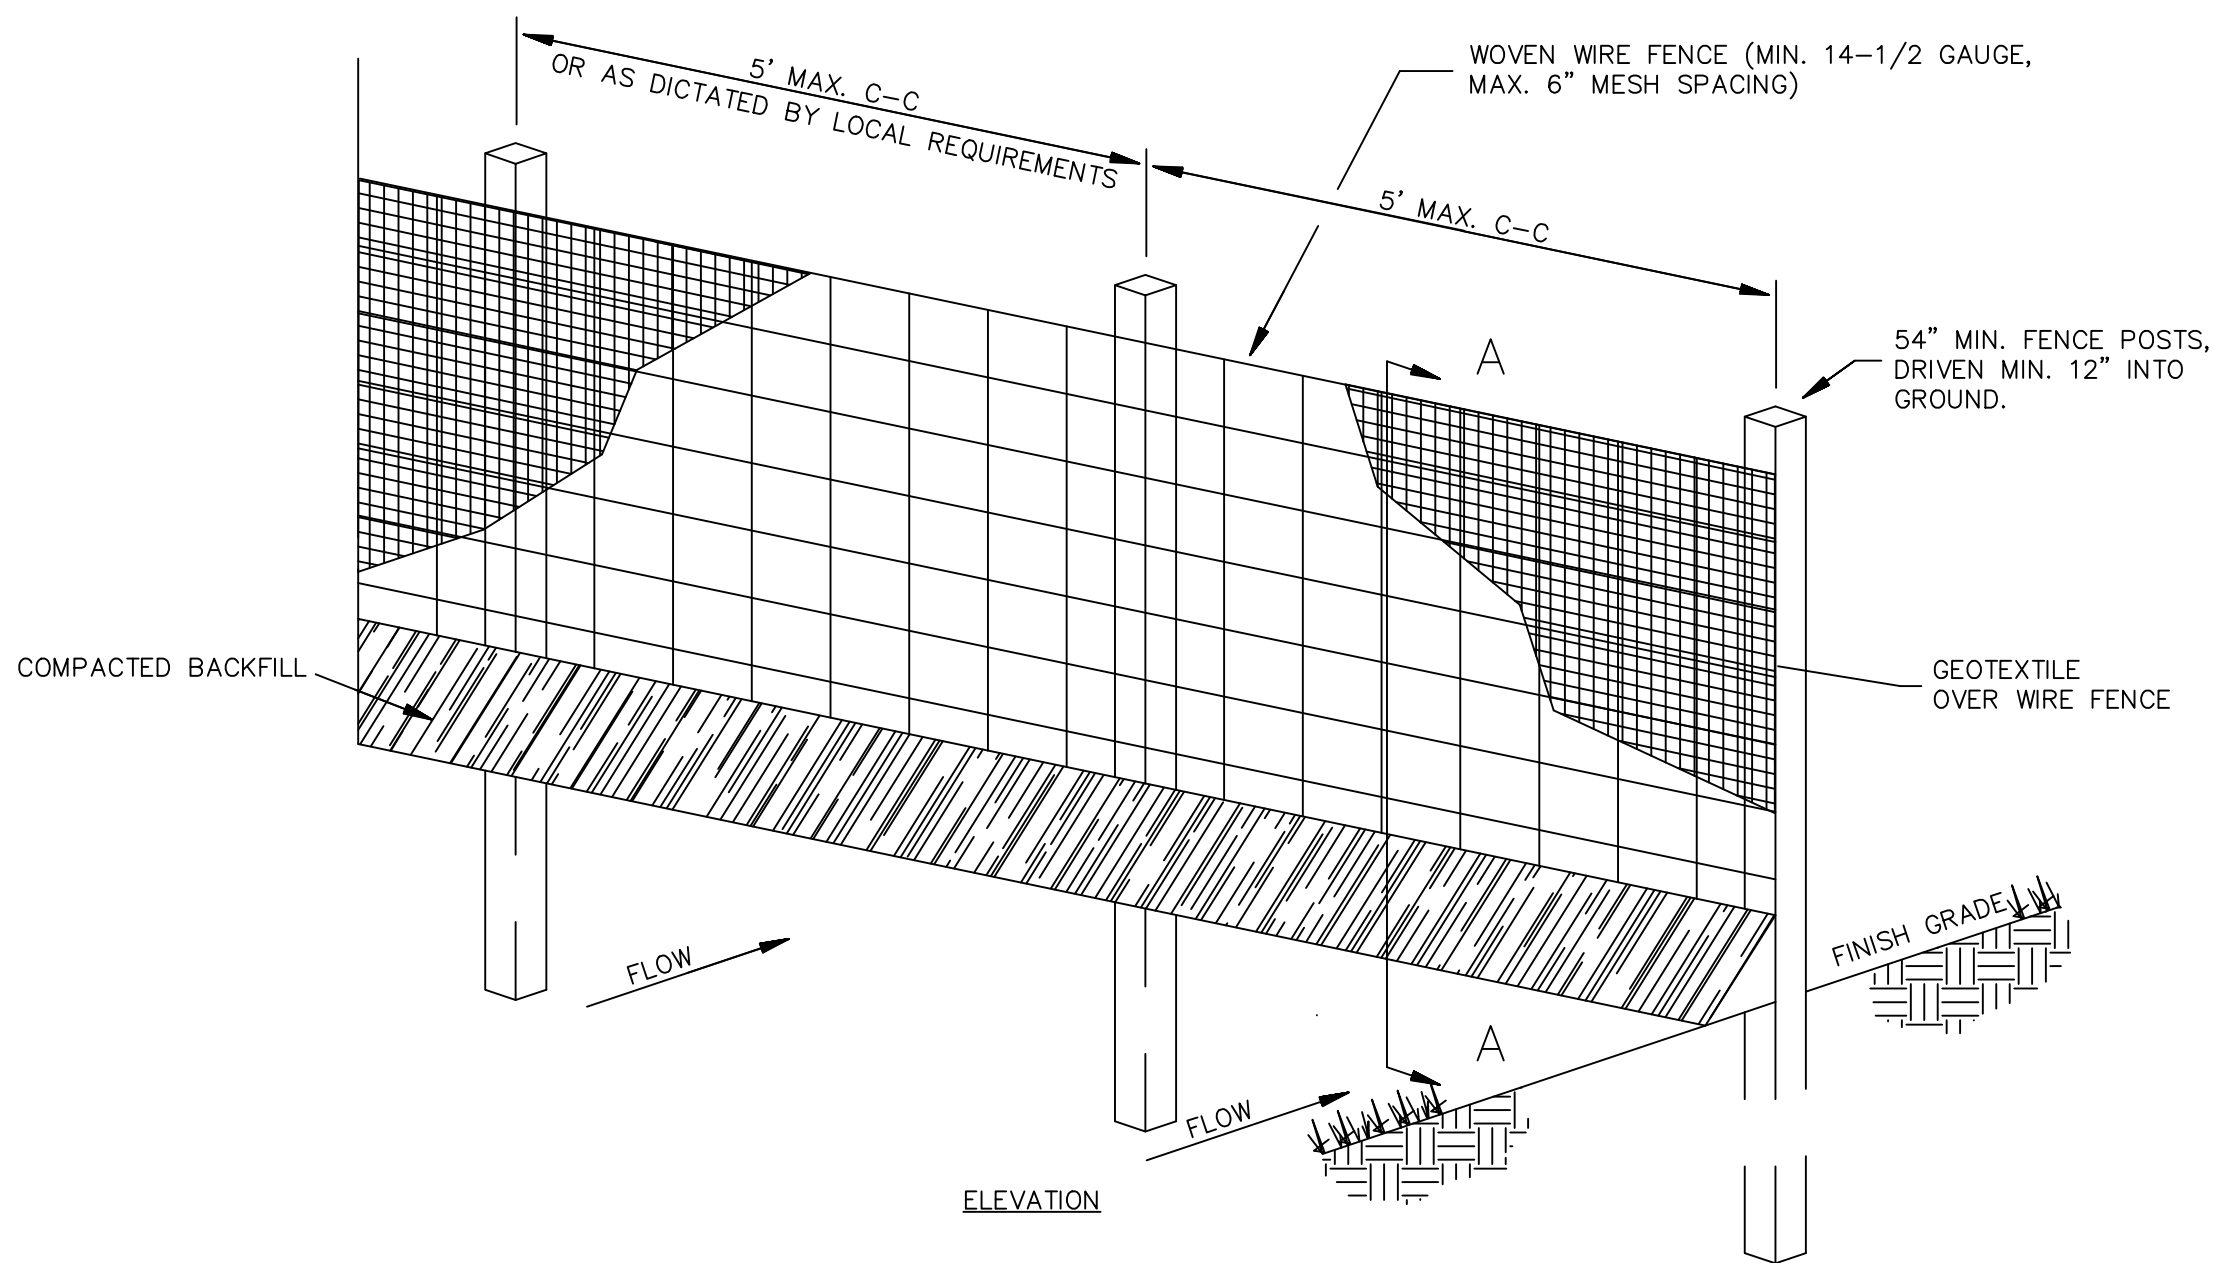

1. WOVEN WIRE FENCE TO BE FASTENED SECURELY TO FENCE POSTS WITH WIRE TIES.
2. GEOTEXTILE TO BE FASTENED SECURELY TO WOVEN WIRE FENCE WITH TIES SPACED EVERY 24" AT TOP AND MID SECTION.
3. WHEN TWO SECTIONS OF GEOTEXTILE ADJOIN EACH OTHER THEY SHALL BE OVERLAPPED BY SIX INCHES AND FOLDED.
4. MAINTENANCE SHALL BE PERFORMED AS NOTED IN THE EROSION CONTROL PLAN. COLLECTED MATERIAL SHALL BE REMOVED WHEN "BULGES" DEVELOP IN THE SILT FENCE.
5. ALL SILT FENCE SHALL INCLUDE WIRE SUPPORT UNLESS INDICATED OTHERWISE

SEDIMENTATION/SILT FENCE WITH WIRE SUPPORT

SCALE: NOT TO SCALE

SCALE:
N.T.S.

ISSUE DATE:
APRIL 22, 2020

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REVISIONS

IFB: APRIL 22, 2019

PROJECT TITLE:
KOSSUTH WATER ASSOCIATION
WATER SYSTEM IMPROVEMENTS - WENASOGA AREA
CDBG PROJECT NO. 1136-19-225-PF-01

SHEET TITLE:
MISCELLANEOUS DETAILS

PROJECT NO.

KWA-19003

SHEET NO.

D-4.0